A.5

MOTION


5. Approval of Form of Development: 219 East 24th Avenue (Formerly 3970-3998 Main Street)

THAT the form of development for this portion of the site known as 219 East 24th Avenue (formerly 3970-3998 Main Street) be approved generally as illustrated in the Development Application Number DP-2022-00729, prepared by Yamamoto Architecture, and submitted electronically on March 14, 2023, provided that the Director of Planning may impose conditions and approve design changes which would not adversely affect either the development character of the site or adjacent properties.

* * * * *

Additional Background Information:

https://www.shapeyourcity.ca/3970-3998-main-st

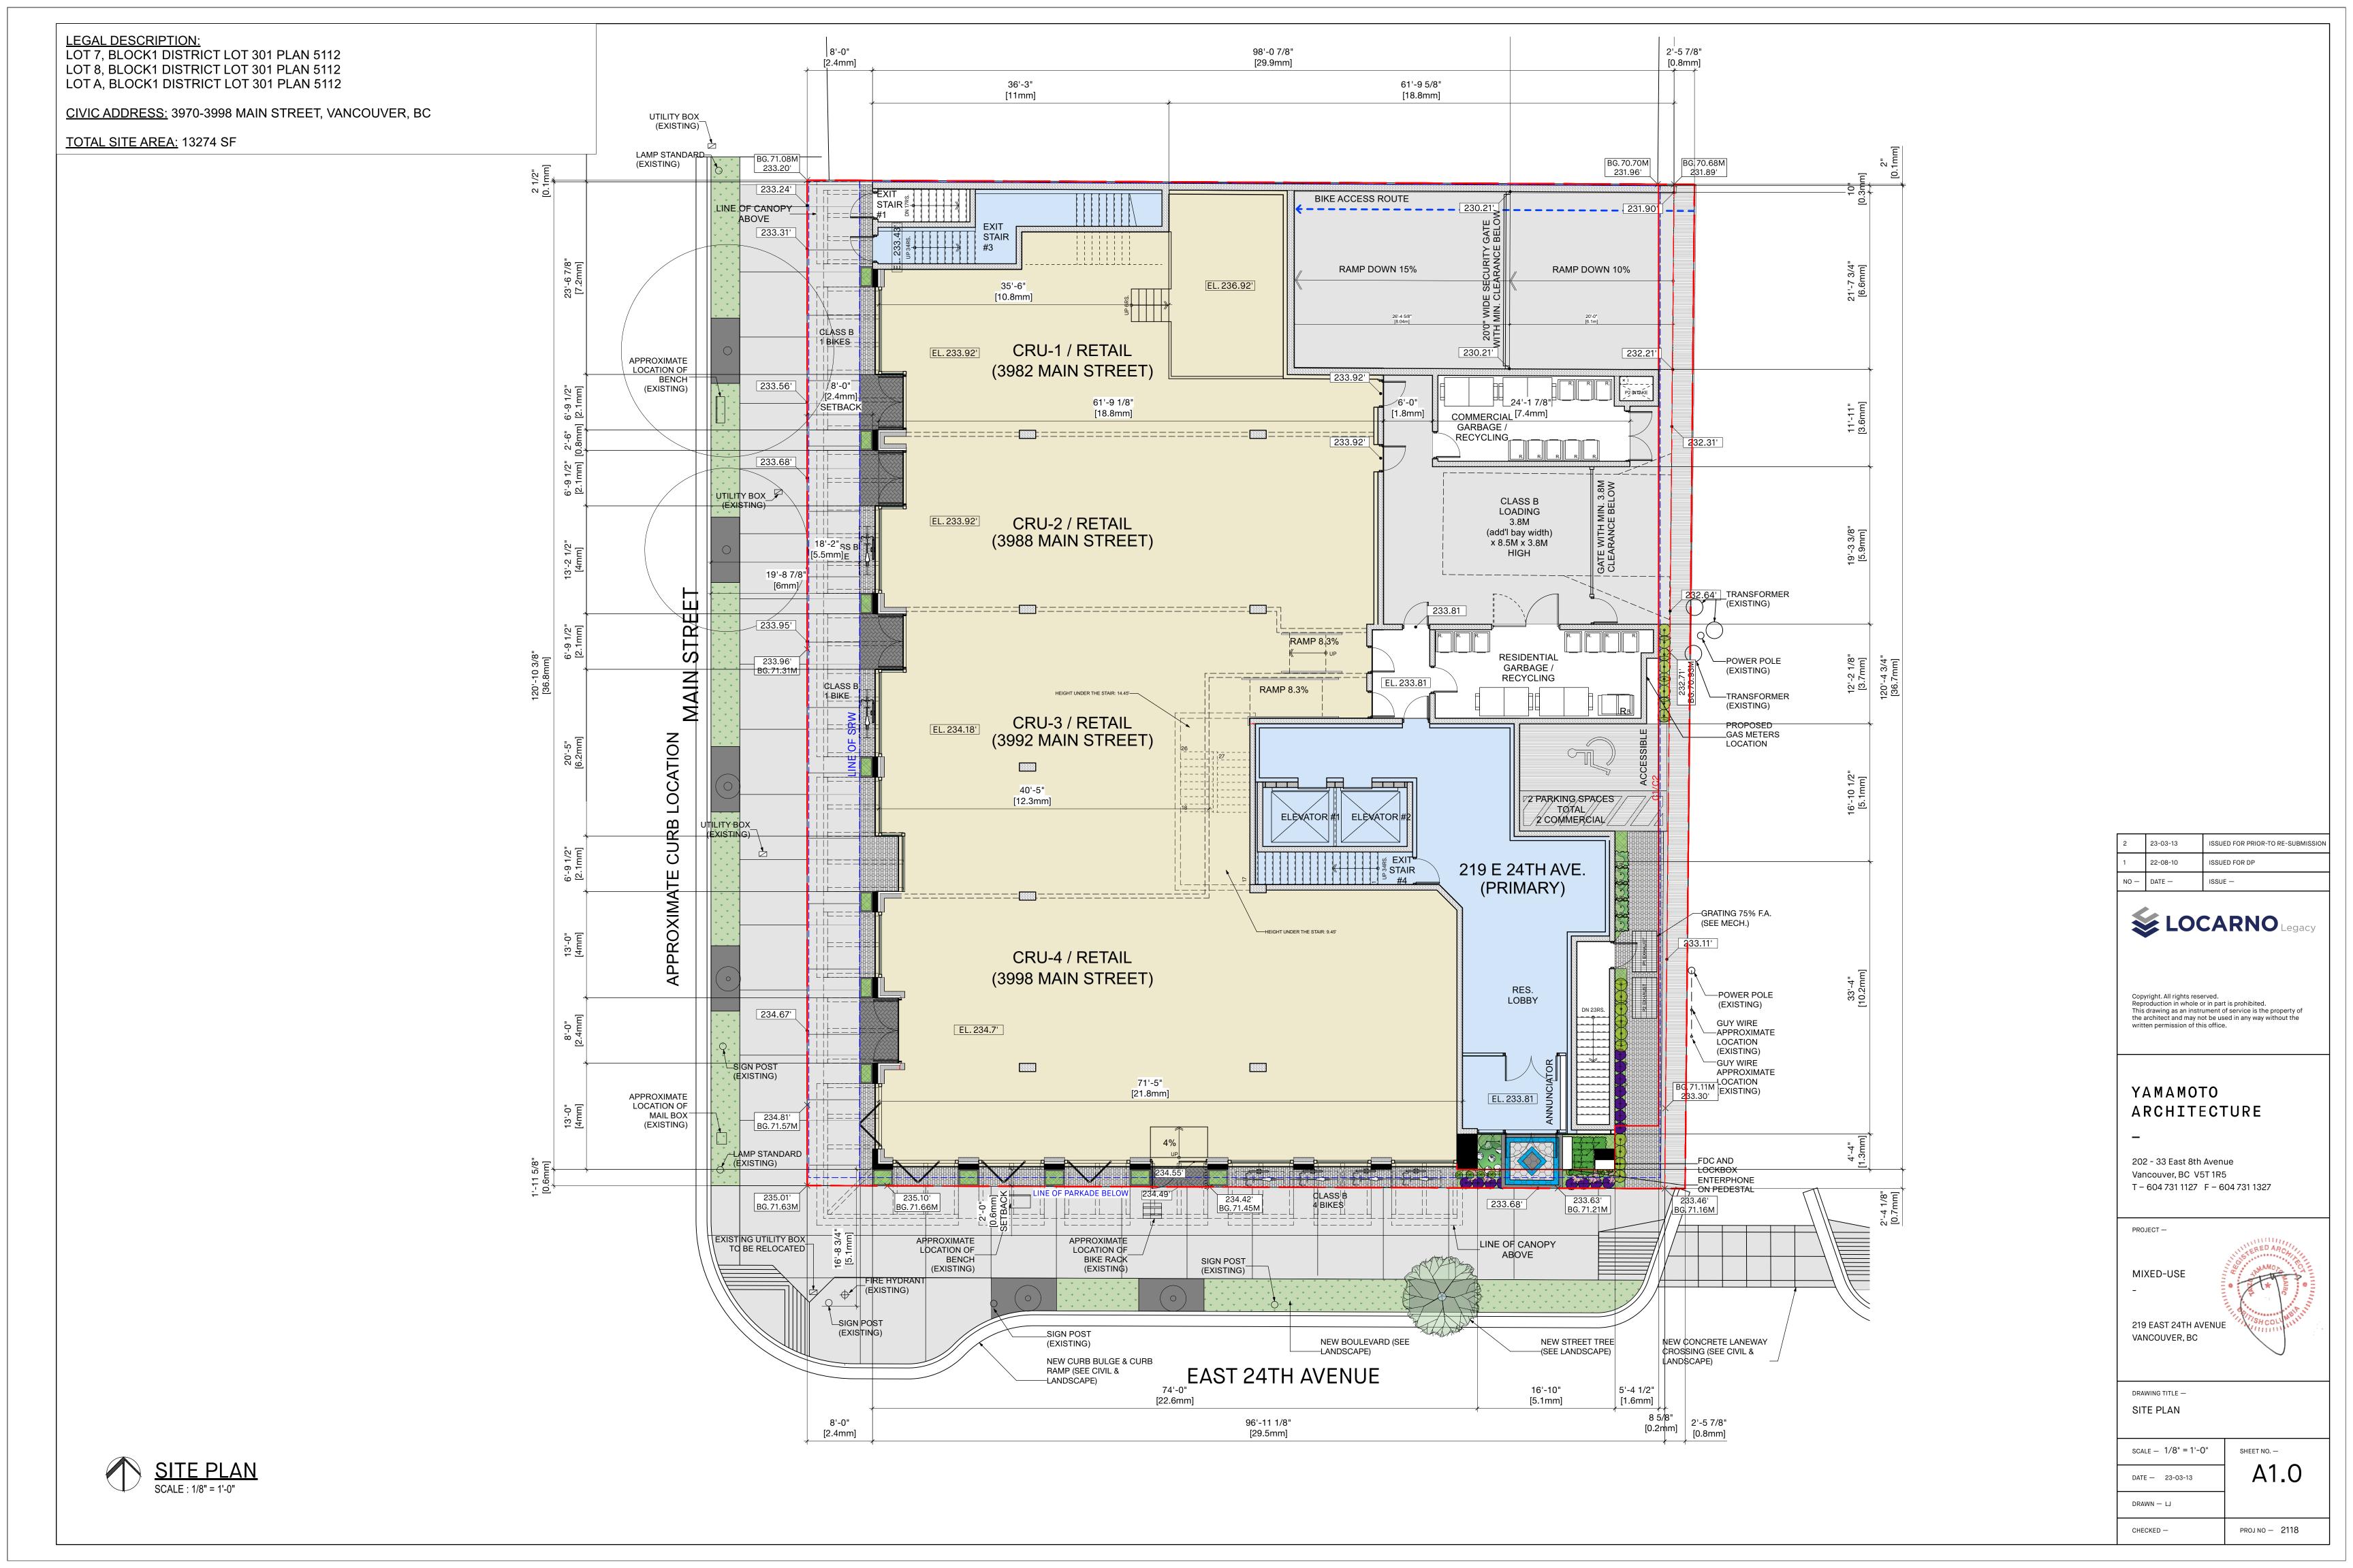



1 BRICK VENEER - LIGHT GREY

2 CONCRETE CAP - CLEAR SEALED

FIBRE-CEMENT PANEL W/COLOUR MATCHED TRIM - PAINTED "GREY"

FIBRE-CEMENT PANEL W/COLOUR MATCHED TRIM - PAINTED "CHARCOAL"

5 FIBRE-CEMENT FASCIA - PAINTED "WHITE"

6 SOFFIT - WOOD GRAIN

7 VINYL WINDOW - "CHARCOAL"

8 METAL AND GLASS GUARDRAIL - CHARCOAL

9 METAL AND GLASS CANOPY - PAINTED "CHARCOAL" W/CLEAR GLASS PANELS

(10) ALUMINIUM STOREFRONT WINDOW - CHARCOAL

(11) GLAZED TILE

12 STOREFRONT DOOR - WOOD GRAIN FINISH

13 PAINTED CONCRETE WITH REVEALS


(14) O.H. GATE - CHARCOAL

(15) LOUVER - CHARCOAL

(16) METAL VENTS TO MATCH SIDING COLOUR

(17) METAL SOLAR SHADE - CHARCOAL

*ALL LISTED MATERIALS REQUIRE SAMPLE REVIEW PRIOR TO PRODUCTION OR INSTALLATION.

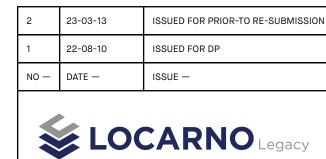

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YAMAMOTO ARCHITECTURE

202 - 33 East 8th Avenue Vancouver, BC V5T 1R5 T - 604 731 1127 F - 604 731 1327

PROJECT —

MIXED-USE

219 EAST 24TH AVENUE VANCOUVER, BC

DRAWING TITLE — WEST ELEVATION

SCALE - 1/8" = 1'-0"DATE — 23-03-13

DRAWN — LJ

 $\mathsf{CHECKED} -\\$

SHEET NO. — A3.1

PROJ NO - 2118

2. ALL EXTERIOR WALLS, WINDOWS AND BALCONY DOORS TO PROVIDE MINIMUM REQUIRED SOUND INSULATION AND PERFORMANCE VALUES AS PER THE SUBMITTED ACOUSTIC REPORT AND SECTION 8 "ACOUSTICS" OF THE DRAFT

1. SEE SUBMITTED ACOUSTIC REPORT PROVIDED BY BKL FOR MINIMUM REQUIRED NOISE INSULATION FOR



1 BRICK VENEER - LIGHT GREY

2 CONCRETE CAP - CLEAR SEALED

FIBRE-CEMENT PANEL W/COLOUR MATCHED TRIM - PAINTED "GREY"

FIBRE-CEMENT PANEL W/COLOUR MATCHED TRIM - PAINTED "CHARCOAL"

5 FIBRE-CEMENT FASCIA - PAINTED "WHITE"

 $\langle 6 \rangle$ SOFFIT - WOOD GRAIN

7 VINYL WINDOW - "CHARCOAL"

8 METAL AND GLASS GUARDRAIL - CHARCOAL

9 METAL AND GLASS CANOPY - PAINTED "CHARCOAL" W/CLEAR GLASS PANELS

(10) ALUMINIUM STOREFRONT WINDOW - CHARCOAL

(11) GLAZED TILE

12 STOREFRONT DOOR - WOOD GRAIN FINISH

13 PAINTED CONCRETE WITH REVEALS

(14) O.H. GATE - CHARCOAL

(15) LOUVER - CHARCOAL

 $\langle 16
angle$ METAL VENTS TO MATCH SIDING COLOUR

(17) METAL SOLAR SHADE - CHARCOAL

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> ISSUED FOR PRIOR-TO RE-SUBMISSION 22-08-10 ISSUED FOR DP **LOCARNO**

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PROJECT —

MIXED-USE

219 EAST 24TH AVENUE

VANCOUVER, BC

DRAWING TITLE — SOUTH ELEVATION

SCALE - 1/8" = 1'-0"

DATE — 23-03-13

 $\mathsf{CHECKED} -\\$

SHEET NO. — A3.2

PROJ NO - 2118

DRAWN — LJ

SOUTH ELEVATION - EAST 24TH STREET
SCALE: 1/8" = 1'-0"

1. SEE SUBMITTED ACOUSTIC REPORT PROVIDED BY BKL FOR MINIMUM REQUIRED NOISE INSULATION FOR

CD-1 BY-LAW.

2. ALL EXTERIOR WALLS, WINDOWS AND BALCONY DOORS TO PROVIDE MINIMUM REQUIRED SOUND INSULATION AND PERFORMANCE VALUES AS PER THE SUBMITTED ACOUSTIC REPORT AND SECTION 8 "ACOUSTICS" OF THE DRAFT



- 1 BRICK VENEER LIGHT GREY
- 2 CONCRETE CAP CLEAR SEALED
- FIBRE-CEMENT PANEL W/COLOUR MATCHED TRIM PAINTED "GREY"
- FIBRE-CEMENT PANEL W/COLOUR MATCHED TRIM PAINTED "CHARCOAL" 5 FIBRE-CEMENT FASCIA - PAINTED "WHITE"
- 6 SOFFIT WOOD GRAIN
- 7 VINYL WINDOW "CHARCOAL"
- 8 METAL AND GLASS GUARDRAIL CHARCOAL
- 9 METAL AND GLASS CANOPY PAINTED "CHARCOAL" W/CLEAR GLASS PANELS (10) ALUMINIUM STOREFRONT WINDOW - CHARCOAL
- (11) GLAZED TILE
- 12 STOREFRONT DOOR WOOD GRAIN FINISH
- 13 PAINTED CONCRETE WITH REVEALS
- (14) O.H. GATE CHARCOAL
- (15) LOUVER CHARCOAL
- (16) METAL VENTS TO MATCH SIDING COLOUR

(17) METAL SOLAR SHADE - CHARCOAL

*ALL LISTED MATERIALS REQUIRE SAMPLE REVIEW PRIOR TO PRODUCTION OR INSTALLATION.

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YAMAMOTO ARCHITECTURE

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PROJECT —

MIXED-USE

219 EAST 24TH AVENUE

VANCOUVER, BC

DRAWING TITLE — EAST ELEVATION

> SCALE - 1/8" = 1'-0"DATE — 23-03-13


SHEET NO. — A3.3 DRAWN — LJ

PROJ NO - 2118 $\mathsf{CHECKED} -\\$

EAST ELEVATION - LANE
SCALE: 1/8" = 1'-0"

1. SEE SUBMITTED ACOUSTIC REPORT PROVIDED BY BKL FOR MINIMUM REQUIRED NOISE INSULATION FOR

2. ALL EXTERIOR WALLS, WINDOWS AND BALCONY DOORS TO PROVIDE MINIMUM REQUIRED SOUND INSULATION AND PERFORMANCE VALUES AS PER THE SUBMITTED ACOUSTIC REPORT AND SECTION 8 "ACOUSTICS" OF THE DRAFT

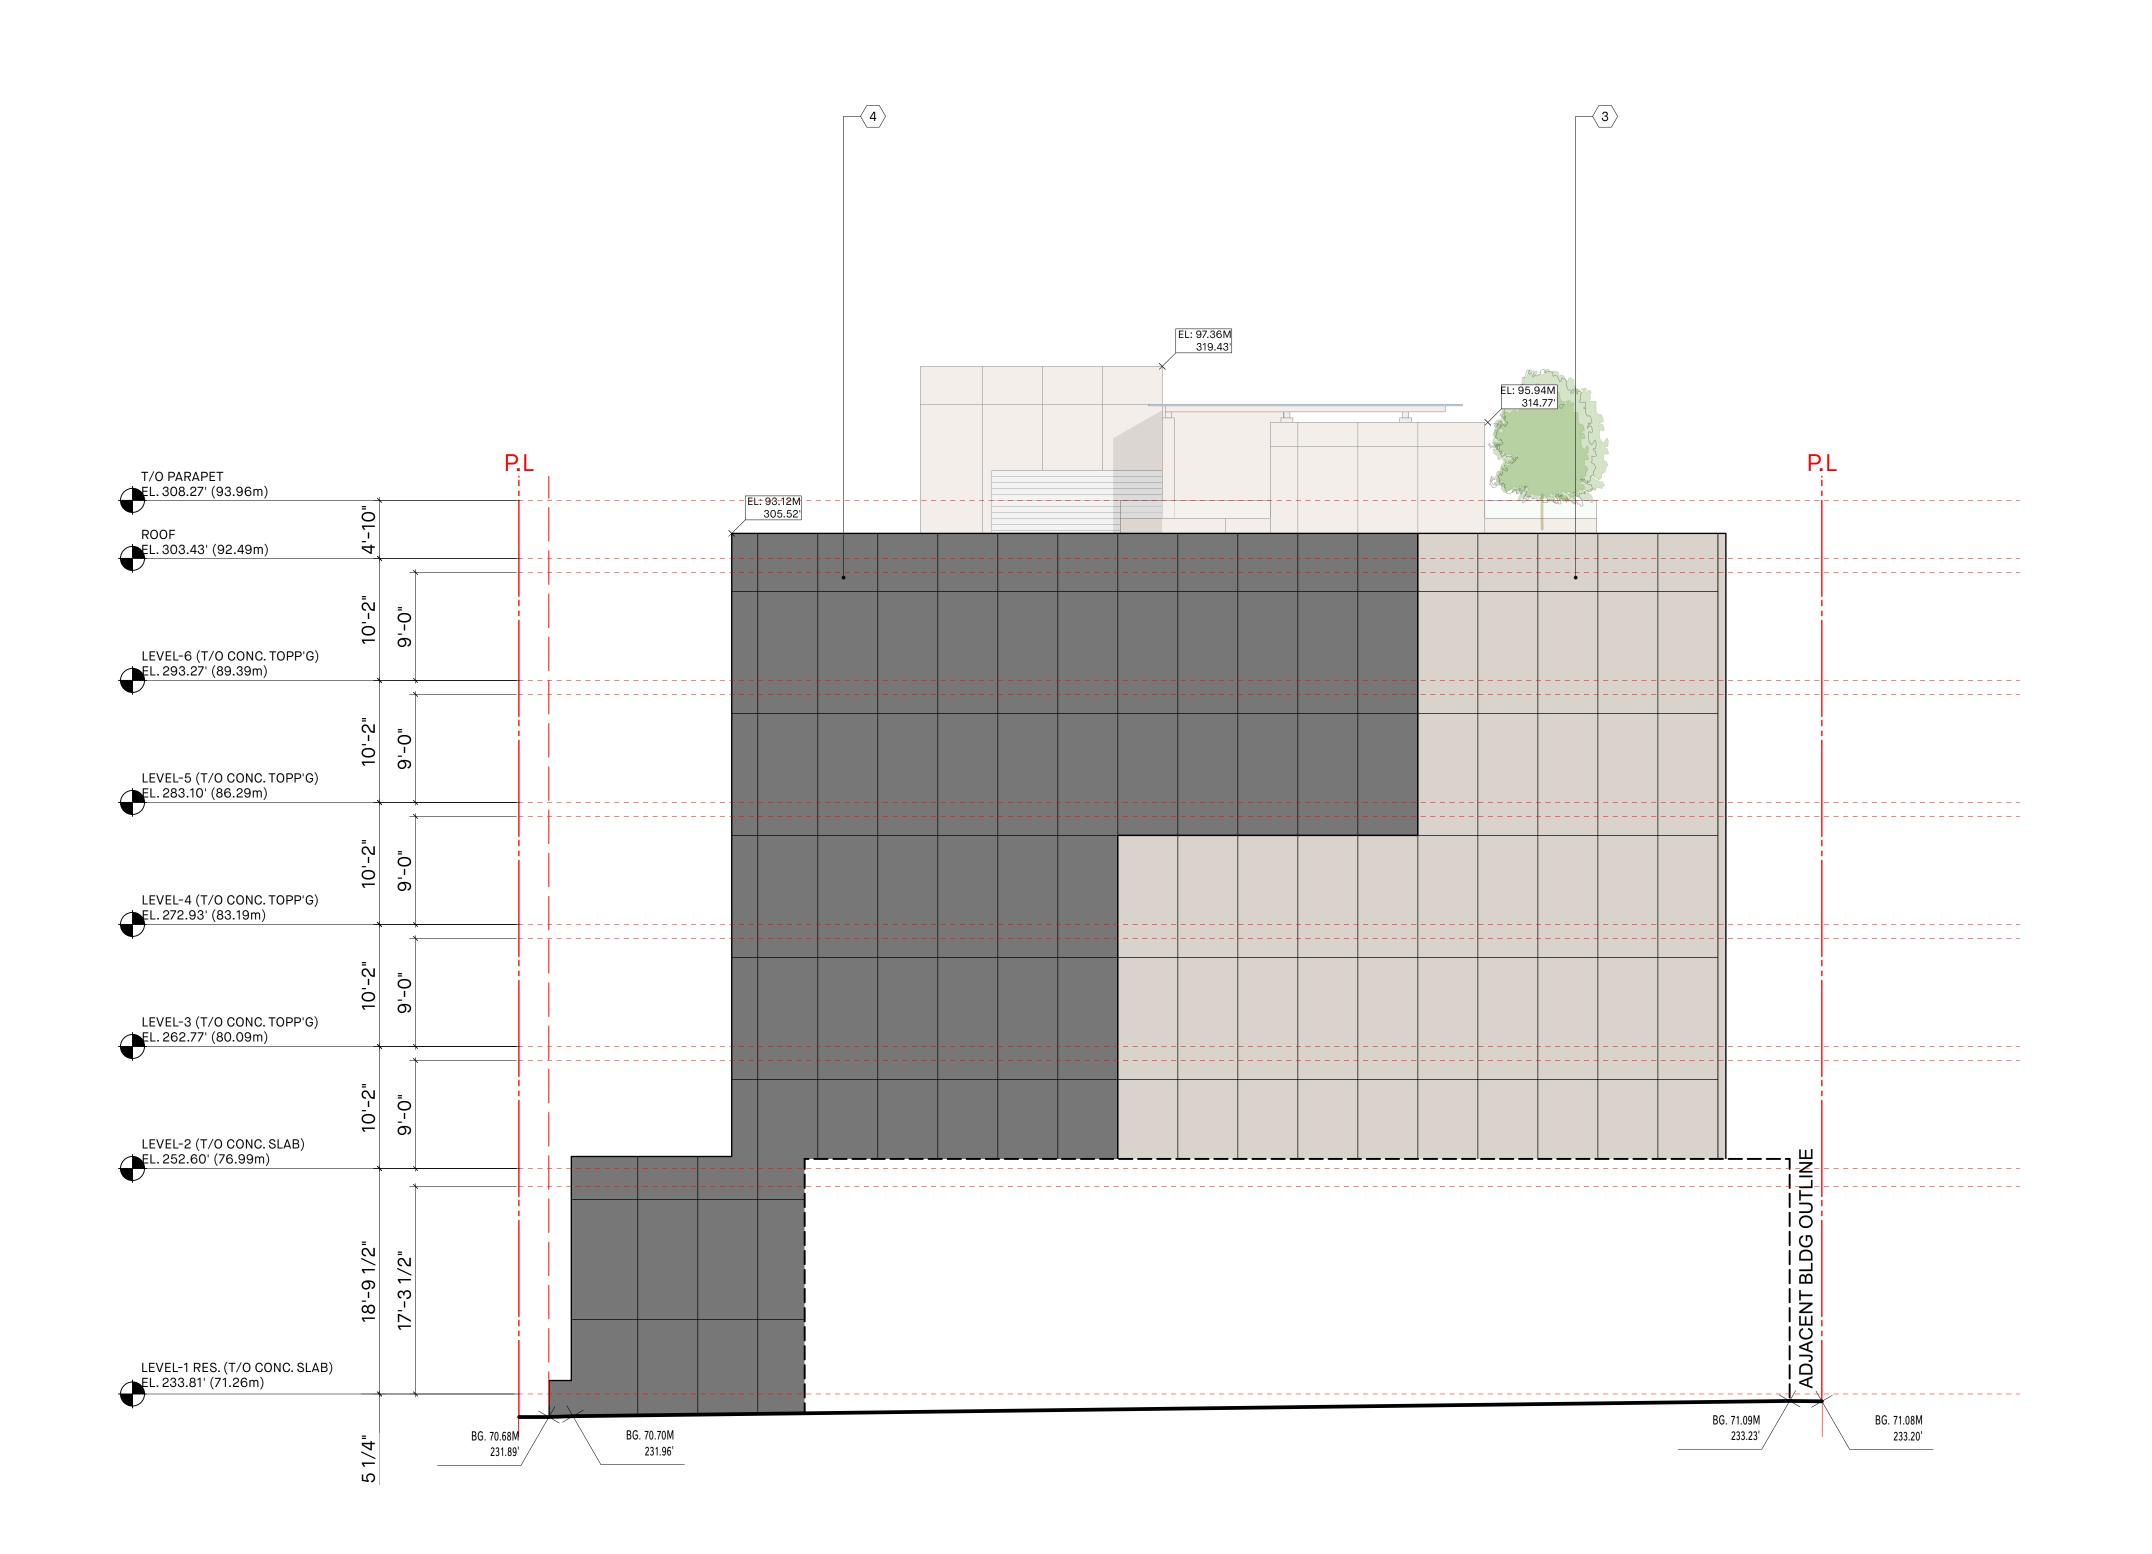

1 BRICK VENEER - LIGHT GREY

2 CONCRETE CAP - CLEAR SEALED

FIBRE-CEMENT PANEL W/COLOUR MATCHED TRIM - PAINTED "GREY"

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PROJECT —

MIXED-USE

219 EAST 24TH AVENUE

VANCOUVER, BC

DRAWING TITLE — NORTH ELEVATION

SCALE - 1/8" = 1'-0"DATE — 23-03-13

SHEET NO. — A3.4

PROJ NO - 2118

2. ALL EXTERIOR WALLS, WINDOWS AND BALCONY DOORS TO PROVIDE MINIMUM REQUIRED SOUND INSULATION AND PERFORMANCE VALUES AS PER THE SUBMITTED ACOUSTIC REPORT AND SECTION 8 "ACOUSTICS" OF THE DRAFT

DRAWN — LJ

 $\mathsf{CHECKED} -\\$

NORTH ELEVATION
SCALE: 1/8" = 1'-0"

1. SEE SUBMITTED ACOUSTIC REPORT PROVIDED BY BKL FOR MINIMUM REQUIRED NOISE INSULATION FOR

CD-1 BY-LAW.