# Cedar Cottage Neighbourhood House Redevelopment

4065 Victoria Dr, Vancouver, BC

# Virtual Public Open House

June, 2022





### PROJECT TEAM



Client

4065 Victoria Drive, Vancouver, BC V5N 4M9



### **Electrical Engineer**

180-200 Granville Street, Vancouver, BC V6C 1S4



### **Transportation**

555-888 Dunsmuir Street, Vancouver, BC V6C 3K4



### **Development manager**

585-1111 W Hastings Street, Vancouver, BC V6E 2J3



### **Civil Engineer**

150-6450 Roberts Street, Burnaby, BC V5G 4G2



### **Architect**

200-1014 Homer Street, Vancouver, BC V6B 2W9



### **Geothechnical Engineer**

275-3001 Wayburne Drive, Burnaby, BC V5G 4W3



### Landscape

1690 W 2nd Ave, Vancouver, BC V6J 1H4



### **Building Envelope**

250-997 Seymour Street, Vancouver, BC V6B 3M1



### **Structural Engineer**

101-190 W 3rd Ave, Vancouver, BC V5Y 1E9



### **Energy Model**

250-997 Seymour Street, Vancouver, BC V6B 3M1



### **Mechanical Engineer**

208-20171 92a Ave, Langley, BC V1M 3A5



### BUILDING SUSTAINABILITY / LEED

757 W 18th Avenue Vancouver, BC V5Z 1W1





### REZONING INTENT

### **Rezoning Intent**

Since it opened its door in 1964 at 4065 Victoria Drive, Cedar Cottage Neighbourhood House (CCNH) has provided important social services to the Cedar Cottage community. The property is owned outright by the non-profit Association of Neighbourhood Houses of BC (ANHBC) and is located on the unceded territory of the Musqueam, Squamish, and Tsleil Waututh Nations.

The intent of this rezoning is to replace the current RS-1A designation with a CD-1 zone, to permit the replacement of the current 716 sm (7,704 sq. ft) building with a larger 1799 sm (19361 sq. ft.) Neighbourhood House. As the area of the site is 1,374 sm (14,786 sq. ft.) the propose density will be 1.31 FSR.

### **Rezoning Proposal**

The new Cedar Cottage Neighbourhood House (CCNH) will consist of series of purpose-built spaces to support the array of services and community development activities that CCNH has historically excelled at. A resource that has contributed to the strong and vibrant neighbourhood that Cedar Cottage has become. The design will be welcoming, flexible and will reflect the diverse cultures of the area. The new facility will allow for the expansion of the existing programs as well as the opportunity to provide new offerings.

The spaces in the new building will include:

- A 37-space licensed childcare facility for infant/toddlers and 2 ½ to 5-year-olds;
- An Adult Day Care facility with associated commercial kitchen;
- Multi-purpose community spaces for small and medium-sized group activities;
- Administration and support spaces.
- Secure covered and open outdoor spaces for the Childcare and
- Underground Parking.

#### Context

The Cedar Cottage neighbourhood is the city's third largest neighbourhood and home to a quarter of the City's residents with increasing densification. The population is diverse in all dimensions and home to a higher-than-average proportion of children and youth. Population projections for Cedar Cottage foresee an increase of up to 60,000 new residents by 2035.

The new facility is designed to meet the demand of the increasing population understanding that many will be new to Vancouver and to Canada. Spaces will be provided that are flexible and welcoming and amenable to programs such as food security, literacy and learning, cultural celebration, and social interaction.

The 40.24m x 33.01m site is situated in a single-family neighbourhood, mid-block between Victoria Drive and Alice Street. Alice Street ends in a cul-de-sac and entrance to Brewer's Park at the end of the block. There is no lane between Victoria Drive and Alice Street.

Lord Selkirk Elementary School is about 3 blocks west of the neighbourhood house. Gladstone Secondary School is about 1.5 blocks to the east. Victoria Drive is on a bus route.







### REZONING RATIONALE

### Applicable Plans, Policies & Guidelines

Kensington-Cedar Cottage Community Vision (1998): This policy recognized that the existing Cedar Cottage Neighbourhood House has outgrown its current facility (Section 4). In addition, the policy, "2.1 Additional Planning not Required Before Rezoning" allows consideration of a Site-Specific Rezoning for an expanded Institution Use such as the Neighbourhood House.

### Culture/Shift: Blanketing the City in Arts and Culture (2019):

CCNH's major goal is to serve the diverse Cedar Cottage community. This is evident in the project's comprehensive consultation process with community members and first nations. Expanding the programs provided with the new facility and viewing the building design through an indigenous lens, fully meets this policy's objectives.

#### Green Building Policy for Rezonings (amended 2018):

Of the two paths under this policy, the project proposes to undertake the B Low Emissions Green Building Path. Given the building's use, this path also requires LEED Gold certification.

### <u>City of Vancouver Childcare Design Guidelines</u> (amended 2021):

The project will conform the design and technical guidelines

#### Parking and Loading Bylaw:

Adhering to the bylaw, the project seeks to minimize the parking requirement by implementing a series of Transportation Demand Measures.

#### Off-street Bicycle Space Regulations:

The rezoning proposal exceeds these regulations.

### **Public Benefits**

The Cedar Cottage Neighbourhood House has been a community asset since 1964. In expanding their facility, CCNH will be able to meet the current and future demands in this growing community. The proposed facilities include a childcare, an expanded Adult Day Program, and an array of community programs.

### **Urban Design Analysis**


The grade within the CCNH property slopes down approximately 3.8m from the south-west corner along Victoria Drive to the north-west corner along Alice Street. Consequently, the proposed building will appear as a two-storey building on the Victoria Drive and as a three-story building on the Alice Street. The single-family houses on both sides of the site, also appear taller on Alice Street, given this grade change.

As a requirement of the rezoning, a portion of the site long Victoria Drive will be dedicated to the City for future road widening, reducing the size of the site.

The proposed setbacks for the new building are:

•	Front Yard along Victoria Drive	3.6m
•	Rear Yard along Alice Street	7.4m
	Side Vards	2.5m



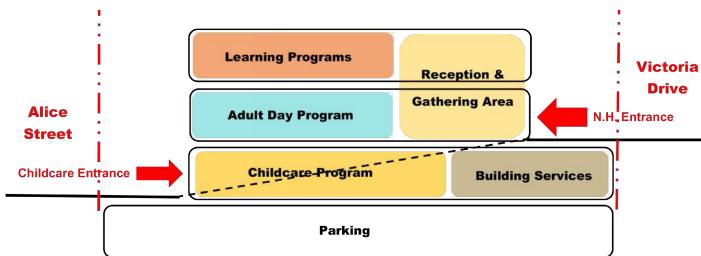



### DESIGN RATIONALE

### **Project Principles**

Through an extensive consultation process with the Cedar Cottage community, nine project principles were identified to guide the design of the new Cedar Cottage Neighbourhood House (CCNH). These principles are:

- 1. Let values lead- capturing the Cedar Cottage DNA;
- **2. Listen, learn, and engage meaningfully-** seek input from many groups;
- **3.** Create a warm and welcoming neighbourhood housebe welcoming to all people;
- **4.** View the project through an indigenous lens- celebrate the legacy of the indigenous peoples;
- **5. Facilitate diversity and inclusion-** create a sense of belonging and cultural safety;
- **6. Ensure comfort, health, safety, and control-** good quality air, temperature, and acoustic control;
- 7. Facilitate flexible spaces for programming and gathering- design for multi-use;
- **8. Encourage social connections** build strong connections across different activities and participants and
- **9. Plan for future generations-** design a durable, low carbon, sustainable, low maintenance building.

These design principles strongly inform the planning and architecture of the new neighbourhood house.

### **Building Organization**

Although the new building is modest in size, it contains a very complex set of program requirements, several requiring licensing approvals. The proposed building organization is a result of a comprehensive engagement process with CCNH and community stakeholders.

The neighbourhood house is arranged on three floors with an additional level of underground parking. The first floor is aligned with Alice Street and accommodates the 37-capacity childcare with its outdoor play area. The second floor, facing Victoria Drive, contains the main entrance to the neighbourhood house, a central Community Living Room, other community and administration spaces and the Adult Day Program. The third or upper floor contains administration spaces, a multipurpose room and a outdoor roof terrace.

While many of the spaces are design for specific program requirements, the plan allows for the flexibility to accommodate other functions when these programs are not running. Of particular importance are two spaces: the central Community Living Room and the Outdoor Roof Terrace facing the sea and mountains. Both these spaces are intended to be used "every day", by individuals or small groups and on "special days" for large gatherings, cultural ceremonies, and events.

### Structural & Mechanical Design

The proposed structural design is a hybrid system comprising a concrete structure for the underground parking and the Alice Street Level and a mass-timber structure above the second floor (Victoria Drive Level).

The proposed mechanical heating, cooling and ventilation system is a low-carbon, hydronic air-source heat pump system with four pipe fan coil units and a central heat recovery system.


#### **Architectural Form**

In developing an appropriate form and expression for the CCNH, consideration was given to:


- The guiding Design Principles summarize above:
- The fit within the context of the single-family neighbourhood
- The recognition of this important resource in the community, by having some visual presence from the street

The building form evolved from the typical typology of a gabled roof form, adopted by many Vancouver neighbourhood houses into a shed roof form, more aligned with the building forms of the local first nations. The two shed roofs organize the overall form of the building. The lower shed roof allows high-level natural light in the Community Living room and covers a portion of the third-floor roof terrace. It also frames the pedestrian-scaled entry porch canopy.


The higher shed roof slopes towards the south to possibly accommodate solar panels and shrouds the roof-top mechanical units. The slope roof folds down toward the property line to reduce the perceived height of the building next to its neighbour.

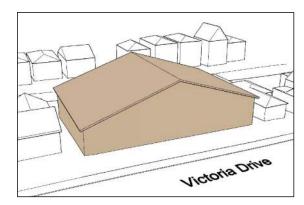

I
Typical gabled roof building.

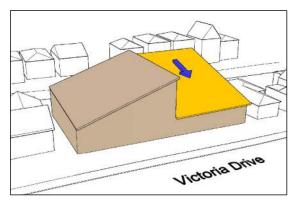


2
Gabled roof turned into two shed roofs.

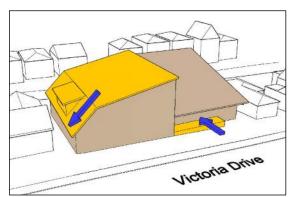

3
The high shed roof folds down to reduce the perceived height.

Set back the east face of the building to allow for a porch.

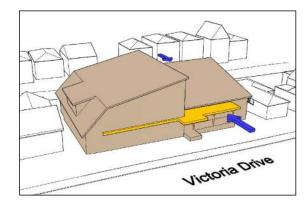

4

Set back the west face at level 3 to allow for a terrace and to bring more natural light into the community living room.

Porch canopy added to reduce scale, create a welcoming entrance, and provide weather protection.



### DESIGN RATIONALE & MATERIALS

### Architectural Expression, Colours and Materials

The architectural design is contemporary and bold while maintaining a welcoming fine-grained character. The horizontal mass-timbered porch canopy and earth-tone brick masonry base recall the cladding on existing neighbourhood house. Framed windows and multi-coloured ACM shingles references the texture of the cedar clad craftsman cottages, while reflecting the vibrancy of the activities within the neighbourhood house.


### Landscape Design

The landscape design of the Cedar Cottage Neighbourhood House is derived from the 9 Project Principles developed by the Project Team over several years. In particular, it aims to meet the goals of creating a warm and welcoming neighbourhood house, to ensure comfort, health, safety, and control, and to encourage social connection.

At the main entry on Level 2 at Victoria Drive, natural landscape elements such as stone slab steps and a rock garden are used to transition from the public realm to the Neighbourhood House, a change in materiality that signals a sense of arrival and welcome. A level path with handrails and seating provides an accessible and comfortable means to reach the front entry as well.

The Level 3 terrace is designed to evoke nature. The concrete "wood" paver, river rock border, and boulder seating accents call to mind the forests, oceans, and mountains of coastal BC. The focal point of the terrace, a canoe-shaped planter, features a native tree and shrubs. Open space is for flexible use is provided on the terrace to allow for community events and moveable furniture.

The outdoor childcare facility on Level 1 provides a large range of imaginative play elements for children to experience. Natural and malleable features such as sand play, children's planters, and a dry steam allow kids to explore the natural world. Active play features such as a tricycle track, playhouse, and climbing structure encourage development of fitness and gross motor skills. The material palette emphasizes low maintenance and durable surfaces, with native and adaptable plant species chosen to further provide an educational element for kids.

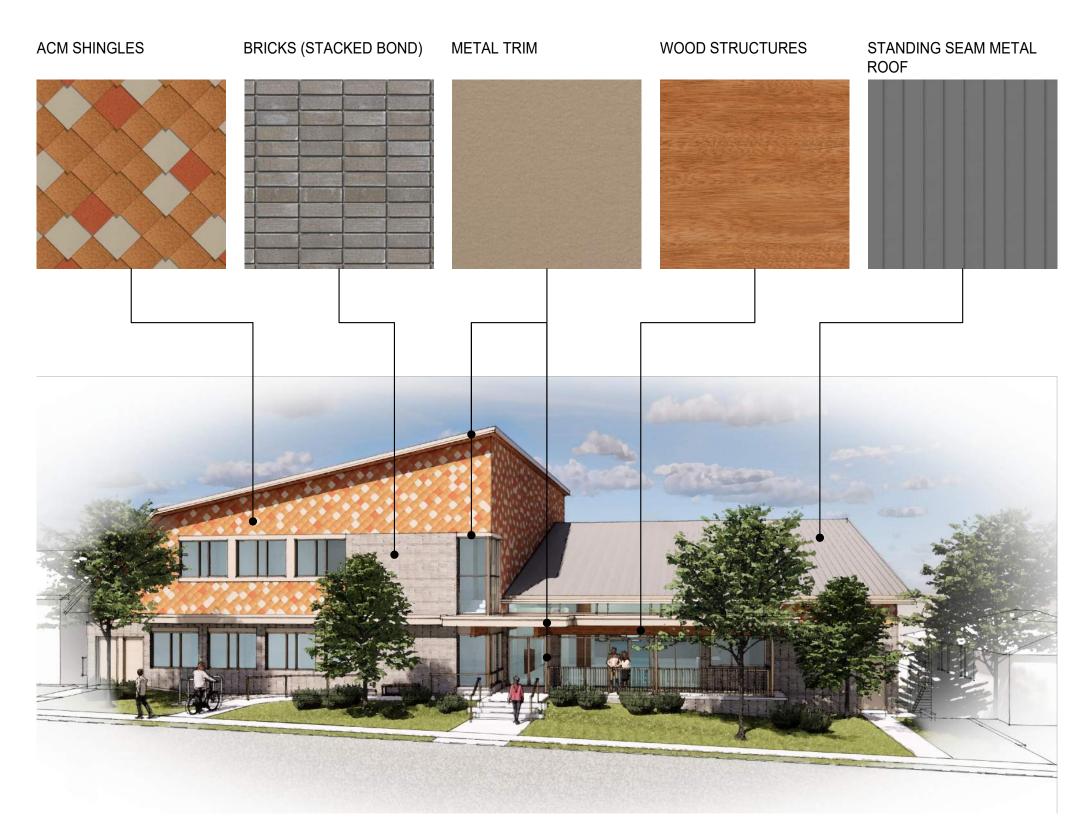



### SUSTAINABILITY MEASURES

### **Environmental Sustainability**

The proposed development pursues the objectives outlined in the 'Green Buildings Policy for Rezonings' through an enhanced commitment to a comprehensive approach, towards providing a comfortable and healthy indoor environment

### **Energy Performance**

The project consists of a 3-storey neighbourhood house, including childcare and adult day program space, multipurpose space, and administrative and support spaces. The project is to comply with the City of Vancouver's Green Buildings Plan for Rezonings using Path B. Significant energy saving design measures include:

- Optimized window to wall ratio, approximately 18%
- Wall insulation with improved effective thermal performance
- Heat recovery with improved efficiency
- High efficiency active chilled beams providing heating and cooling
- Reduced greenhouse gas emissions by supplying heating and hot water through low carbon electricity using highly efficient air-source heat pumps
- Daylight sensors and occupancy sensors, as well as a reduction in installed lighting power density

The building falls under the "all other buildings" category for Rezoning energy performance targets, which requires 35% lower EUI compared with a VBBL baseline. An NECB 2015 baseline, complying with VBBL rules, has been developed. TEDI and GHGI targets do not apply but have been reported for information.

In addition, the project is pursuing LEED v4 Gold, with 14+ energy points currently anticipated. If EApc95 is pursued (in the event that natural gas backup is used), potentially up to 18 points may be available.

If renewable energy via rooftop PV is pursued, it would potentially generate approximately 710% of the modeled annual energy for the building. This would also provide additional LEED points both under the renewable energy category as well as an additional 2-3 points under the energy modelling credit. A number of energy decisions have yet to be made and model will be updated as the design develops.

### Integrated Rainwater Management & Green Infrastructure

The rainwater management system for this site has been designed in accordance with the CityWide Integrated Rainwater Management Plan criteria

and the Rezoning Policy for Sustainable Large Developments requirements. Hydrologic models were computed for the post-development condition and compared with the predevelopment condition, and against the targets established in the Rainwater Management Bulletin: retain or detain the first 24 mm of rainfall in 24 hours over all areas of the proposed lot, limit the release rate from the post-development site to be equal or less than the predevelopment condition, and treat the runoff to remove at least 80% of Total Suspended Solids (TSS) from the runoff prior to releasing it to the City drainage system.

The proposed Rainwater Management Plan for this development meets the above targets with the following measures:

- Peak flow will be controlled with the installation of flow control manhole
  with an appropriately sized orifice and a storage tank to support the
  reduced release rate (governed by detention). An overflow riser will also
  be provided in the flow control manhole to allow higher runoff rates to
  flow into the City system
- Volume reduction will be achieved with retention of 7.03 m3 in planting, and remainder volume of 26.44 m3 will be captured with a detention tank with a capacity of 26.8 m3. Accordingly, an orifice sized to release 2.5 liters per second will be provided to ensure the required detention is met.
- The runoff will be conveyed through a Jellyfish treatment system to remove at least 80% of Total Suspended Solids.

### Transportation

Cedar Cottage Neighbourhood House shall provide individualized, tailored marketing and communication campaigns to promote and encourage the use of sustainable transportation modes, such as walking, cycling, rolling, and transit, for employees and clients. These marketing services will be provided in house for a minimum of 20 years. The marketing services shall include, at a minimum, the following activities:

- Promotions: The TDM coordinator shall develop and deploy promotions to encourage use of sustainable transportation modes. This will include targeted messaging and communications campaigns, incentives and contests, and other creative strategies. These campaigns will target employees.
- Welcome Packets: The TDM coordinator shall provide new employees with tailored information about sustainable transportation options associated with accessing the site as part of a welcome pocket. This information may include, but not be limited to, public transit routes and schedules. For employees, the packet will include information on commuting options from major origins in the Metro Vancouver region.
- Travel Planning: The TDM coordinator will provide ongoing opportunities for one-on-one consultation about sustainable transportation options for employees when requested.

### **Economic Sustainability**

As an energy efficient, low maintenance building, the new Neighbourhood House will enhance the long-term economic capability of this important community resource.

### Social Sustainability

The Cedar Cottage Neighbourhood House has been a community asset since 1964. In expanding their facility, CCNH will be able to meet the current and future demands in this growing community. The proposed facilities include a childcare, an expanded Adult Day Program, and an array of community programs.

The new facility is designed to meet the demand of the increasing population understanding that many will be new to Vancouver and to Canada. Spaces will be provided that are flexible and welcoming and amenable to programs such as food security, literacy and learning, cultural celebration, and social interaction.

### Landscaping

The landscape design of the Cedar Cottage Neighbourhood House aims to meet the goals of creating a warm and welcoming neighbourhood house, to ensure comfort, health, safety, and control, and to encourage social connection. Drought resistant and native plant species will be used on site to minimize the need for watering. Also, Plants that enable bird-friendly habitat conservation and promotion have been selected and can be found throughout the landscape.













# SUSTAINABILITY MEASURES

	LEED	O v4 and v4.1 Building Design + Construction:		ijor Reno <b>1</b>	vation, p				0 1 0 4 1 1 1 1 1 1 1 1 1 1 1 1 1 1 1 1	D. 1	7
USGBC		LEED Checklist and Responsibilities		_		Project	: Na	me:	Cedar Cottage Neighbourhood House	Redevelopment	4
	Т	arget: LEED Gold Certification, CoV Green Bu	uilding Policy 60 points	]		Date:			2022 May 4		
Υ?	1_	LEED Documentation - Respon	nsible Design Team Specialist						BLUE CAMAS CONSULTING, LEI	D Coordinator	
1	Credit	Integrative Process (DESIGN STAGE)	OWNER/LEED	1							
				10		Υ ΄	?	N	LEED Documentation - Response	nsible Design Team Specialist	t
10 1 3	_	ocation and Transportation		16		5 5	5	-	R - Materials and Resources		13
		LEED for Neighborhood Development Location	not applicable to this project	16	,	Y			req Storage and Collection of Recyclables (DESIGN)	ARCH/LEED	Required
1		Sensitive Land Protection (DESIGN)	OWNER/LEED	1		Y		Pren	req Construction & Demo. Waste Management Planning	CONTRACTOR	Required
2	2 Credit	High Priority Site		2		1 1		3 Cred	(· · · · · /	LEED	5
4 1		Surrounding Density & Diverse Uses (DESIGN)	OWNER/LEED	5		1 1		Cred	Environmental Product Declarations (V4.1)	CONTRACTOR	2
2		Access to Quality Transit (v4.1, DESIGN)	ARCH/LEED	5		1 1		Cred	dit B.P. D & O - Sourcing of Raw Materials (V4.1)	CONTRACTOR	2
1		Bicycle Facilities (DESIGN)	ARCH/LEED	1		1 1		Cred		CONTRACTOR	2
1		Reduced Parking Footprint (v4.1;DESIGN)	TRANSPORT. PLANNER	1		1 1		Cred	dit Construction & Demo Waste Manage. (V4.1)	CONTRACTOR	2
1	Credit	Green Vehicles (V4.1;DESIGN)	ELECTRICAL ENG.	1				- Constant			
					1	1000	3	-	Q - Indoor Environmental Quality		16
5 5 (	PRO-000-00-00-00-00-00-00-00-00-00-00-00-0	Sustainable Sites		10		Y			min Indoor Air Quality Perform.(DESIGN;CoV)	MECHANICAL ENG.	Required
Y		Construction Activity Pollution Prevention	CIVIL ENG.	Required		Y		Pren	req Env.Tobacco Smoke Control(V4.1;DESIGN)	OWNER/LEED	Required
1		Site Assessment (DESIGN)	OWNER/ARCHITECT	1		2		Cred		MECHANICAL, ARCHITECT	2
1 1		SiteDev. Protect/Restore Habitat (V4.1)	LANDSCAPE ARCH.	2		2		Cred	,	CONTRACTOR	3
1	_	Open Space (V4.1)	LANDSCAPE ARCH.	1		1		Cred	concension made in a case, in the case is a case in the case is a case in the	CONTRACTOR	1
3		Rainwater Management (V4.1;DESIGN;CoV)	CIVIL, LANDSC., ARCH (MECH)	3		2		Cred	,,,,,,	IAQ TESTER, CONTRCTR	2
2		Heat Island Reduction (DESIGN,Roof+100%u/g)	ARCH/LEED	2		1		Cred		MECHANICAL ENG.	1
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					,	2.4		2 Cred	, _ , , ,	ELECTRICAL ENG.	3
4 3 2	_	Water Efficiency		11		1		Cred	,	ARCH/LEED	1 1
Y		Outdoor Water Use Reduction (DESIGN)	LANDSCAPE ARCH.	Required				Cred	dit Acoustic Performance (v4.1, DESIGN)	ACOUSTIC	1
Y		Indoor Water Use Reduction (DESIGN)	MECHANICAL ENG.	Required							
Y		Building-Level Water Metering (DESIGN)	MECHANICAL ENG.	Required		4 2	_	1000000	I - Innovation		6
1 1		Outdoor Water Use Reduction (DESIGN)	LANDSCAPE ARCH.	2		3 2	2	-	Innovation or Exemplary Performance	OWNER, LEED	5
2 2	-	IndoorWaterUseReduction (DESIGN, 30%Reduct.)	MECHANICAL ENG.	6		1		Cred	t LEED Accredited Professional	LEED	1
4		Cooling Tower Water Use		2							
	Credit	Water Metering (DESIGN)	MECHANICAL ENG.	1		1 3	5		P - Regional Priority	EUEDOV MODELED	4
40 40	EA	Energy and Atmosphere			1	1			dt RP: Optimize Energy Performance	ENERGY MODELER	4 1
		Energy and Atmosphere	0-4	33					mt RP: Enhanced Cx min 5 pts (incl Envelope Cx)	CxA	4 ;
Y		Fundamental Commissioning and Verification(CoV Min Energy Performance (DESIGN;CoV)		Required Required		2.0		-	<ul> <li>RP: Building Life-cycle Impact Reduction min 3 pts</li> <li>RP:Rainwater Management min 85th Percentile 2pt</li> </ul>	LEED CIVIL LANDSC ARCH	- 1
Y			ENERGY MODELER MECHANICAL, ELECTRICAL					Cred	RP.Rainwater Management min ooth Percentile 2pt	CIVIL, LANDSC, ARCH	_ '
Y		Building-Level Energy Metering (DESIGN;CoV)		Required		CO 2	2	40		Dossible Deinter	440
0 0	-	Fundamental Refrig.Manag.(DESIGN;CoV)	MECHANICAL ENG.	Required		60 3	2	10	Cartified, 40 to 40 points. Ciberry FOA: FO points. O. 11 CO. 7	Possible Points:	110
3 3		Enhanced Commissioning (CoV, add Envelop Cx?)	CxA	6	NOTEC	0000 5	00	_	Certified: 40 to 49 points, Silver: 50 to 59 points, Gold: 60 to 7	points, <b>Platinum:</b> 80 to 110	
14 4	-	Optimize Energy Performance (DESIGN)	ENERGY MODELER	18	NOTES:	2022 04	22 -	Energy	y Model Draft Report		
		Advanced Energy Metering (DESIGN;CoV)	MECHANICAL, ELECTRICAL			-					
		Demand Response	OWNED ENERGY FLES	2							
1 1 2		Renewable Energy Production	OWNER, ENERGY, ELEC	3		-					
	_	Enhanced Refrig.Manag.(DESIGN;CoV)	MECHANICAL ENG.	┨		<u> </u>					
2	Credit	Green Power and Carbon Offsets	OWNER, ENERGY, ELEC	2							

# PHOTOS & EXISTING STREETSCAPE































# EXISTING & PROPOSED STREETSCAPE



**EXISTING VICTORIA DRIVE STREETSCAPE** 



PROPOSED VICTORIA DRIVE STREETSCAPE




**EXISTING ALICE STREET STREETSCAPE** 



PROPSOED ALICE STREET STREETSCAPE

# SHADOW STUDY



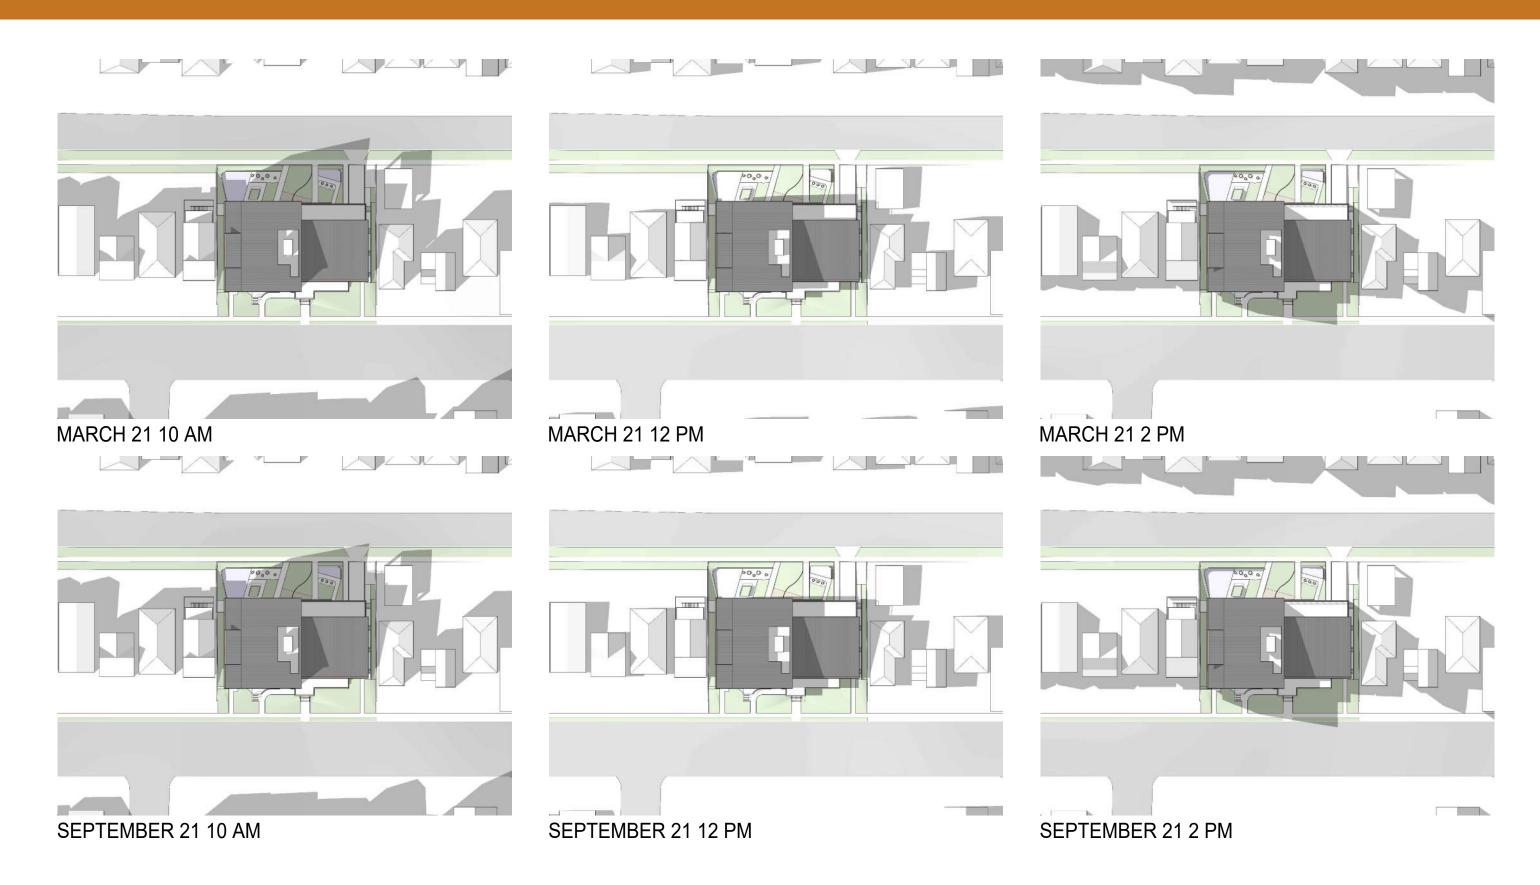



# PROJECT DATA

### **Project Statistics**


Zoning Requirements	Currrent Zoning	Proposed Zoning
Development Zone	RS-1A	CD-1
Conditional Approval Use	Neighbourhood House	Neighbourhood House
Site Area	1374.2 sm (14,786 sq.ft.)	1374.2 sm (14,786 sq.ft.)
FSR	0.6 (plus exemptions)	1.31
FSR Area	824.5 sm (8,872 sq. ft.)	1799 sm (19361 sq.ft.)
Building Height	10.7m (2 1/2 Storeys)	13.9 m (45'-7")
Setbacks Front Yard	6.61-7.04m (21'-8"-23'-1")	3.6 m (11'-10")
Side Yards	1.5m (5'-0")	2.5 m (8'-2")
Rear Yard	10.2m (33-6")	7.4 m (24'-3")
Site Coverage (incl. impermeable materials)	60%	69%
Vehicular, Loading & Bicycle Requirements	Required	Proposed
Vehicular Parking Requirements		
Regular Stalls		17
Disabled Stalls		2
	To be confirmed	19
Loading Requirements		
Community Centre:	0	1 Class A
Bicycle Storage Requirements		
Class A	0	11
Class B	6	11

Proposed Floor Plate Areas					
	sm	sq. ft.			
Mech. Penthouse	36	384			
Level 3	417	4485			
Level 2- Victoria Ave.	715	7701			
Level 1- Alice Street	631	6791			
Total FSR Area	1799	19361			
Parking Level	1128	12140			
Gross Building Area	2927	31501			

Childcare Proposed Areas							
	To	tal	Infant / Toddle	er (12 children)	2 1/2 - 5 years (26 Children)		
	sm	sq.ft.	sm	sq.ft.	sm	sq.ft.	
Gross Indoor Area	411	4422	-	-	-	-	
Covered outdoor Play Area	85	915	36	387	49	528	
Total Outdoor Play Area	396	4249	131	1407	265	2842	

# **CONTEXT PLAN**




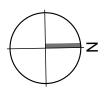


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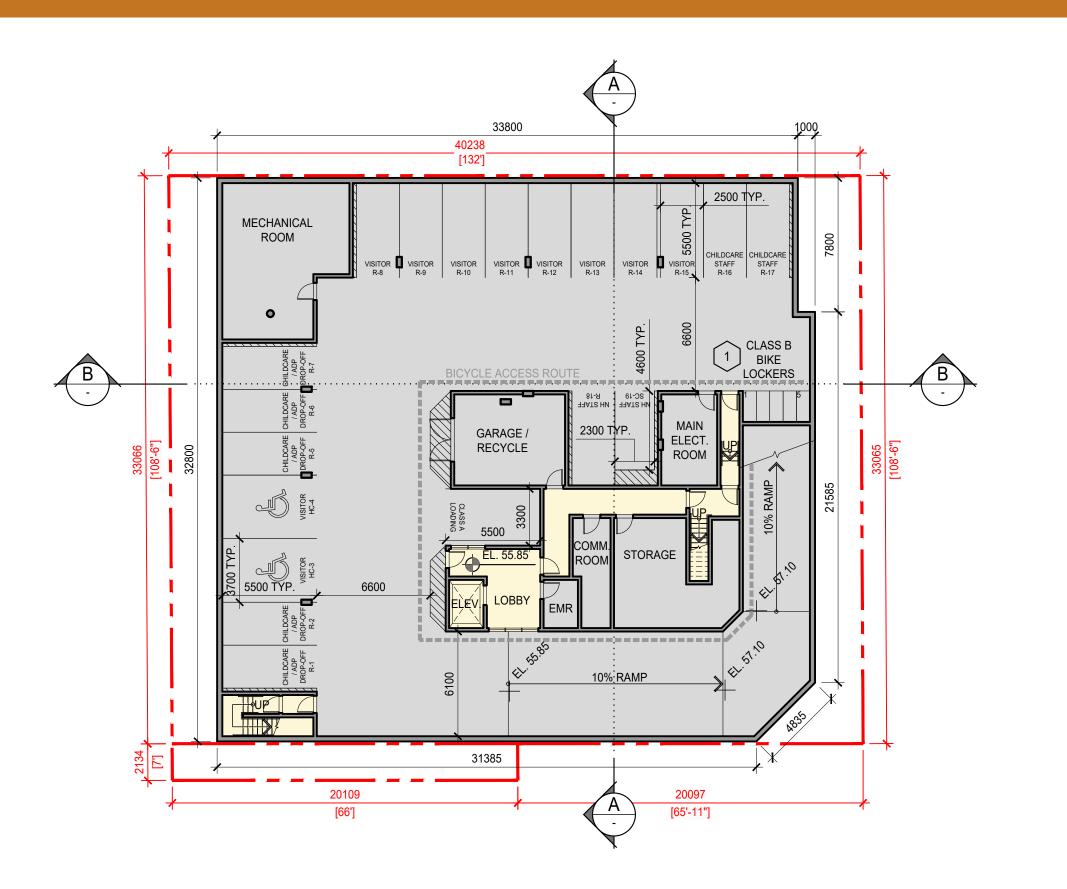
# SITE PLAN




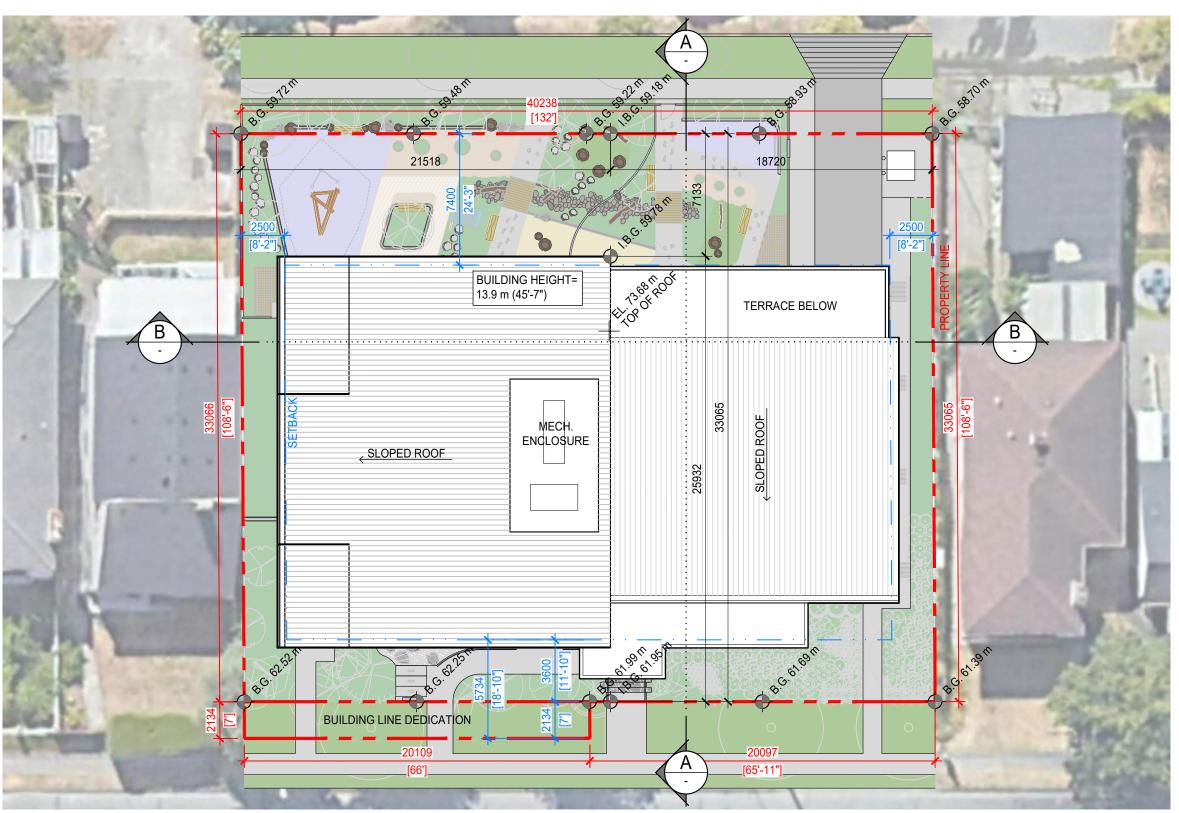

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### PARKING FLOOR PLAN

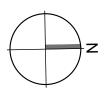

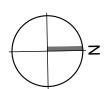


### TDM KEYNOTES:


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ACT-03: ENHANCED CLASS B BICYCLE PARKING



### LEVEL 1 FLOOR PLAN



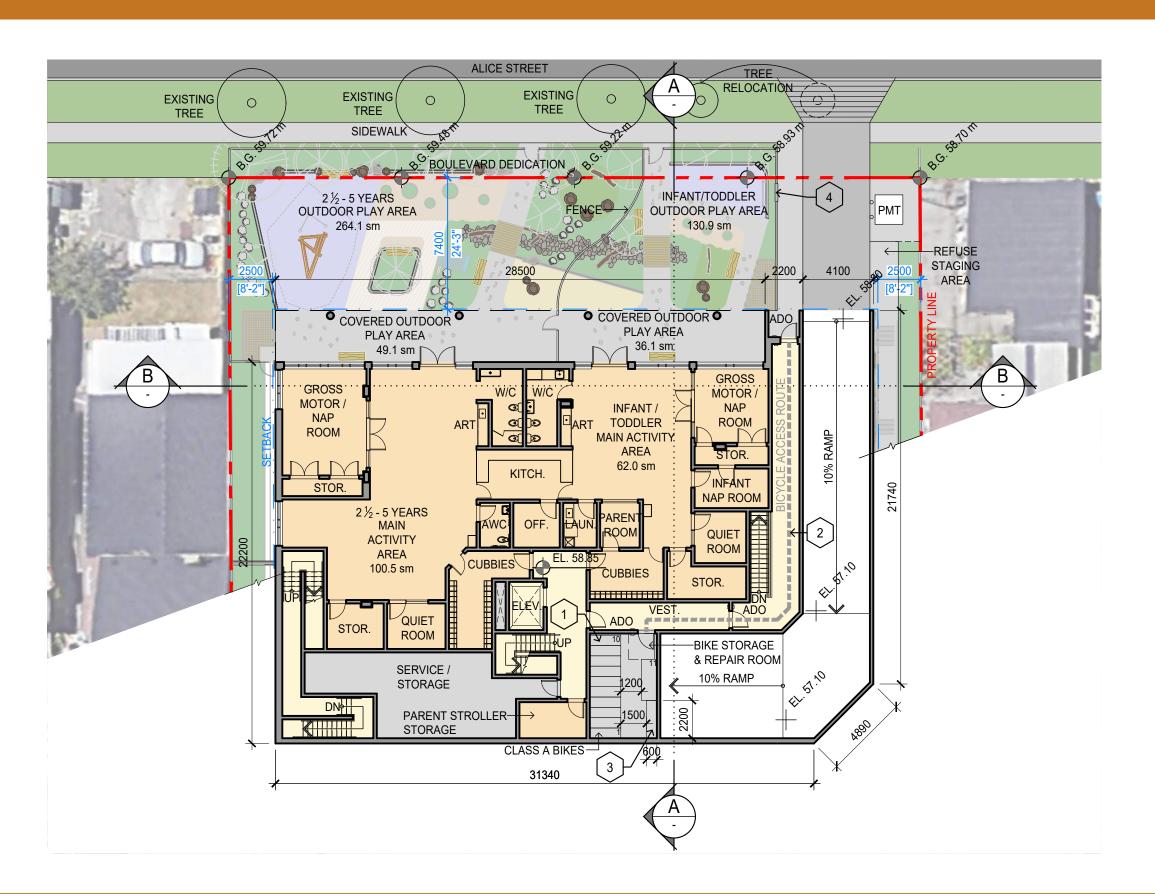


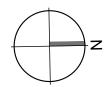
#### TDM KEYNOTES:

- ACT-01: ADDITIONAL CLASS A BICYCLE PARKING
- ACT-02: IMPROVED ACCESS TO CLASS A BICYCLE PARKING (100% AT-GRADE)
- 3 ACT-05: BICYCLE MAINTENANCE FACILITY
- 4 SUP-03: MULTIMODAL WAYFINDING SIGNAGE
- 0 1 2 5 10 METERS



# LEVEL 2 FLOOR PLAN

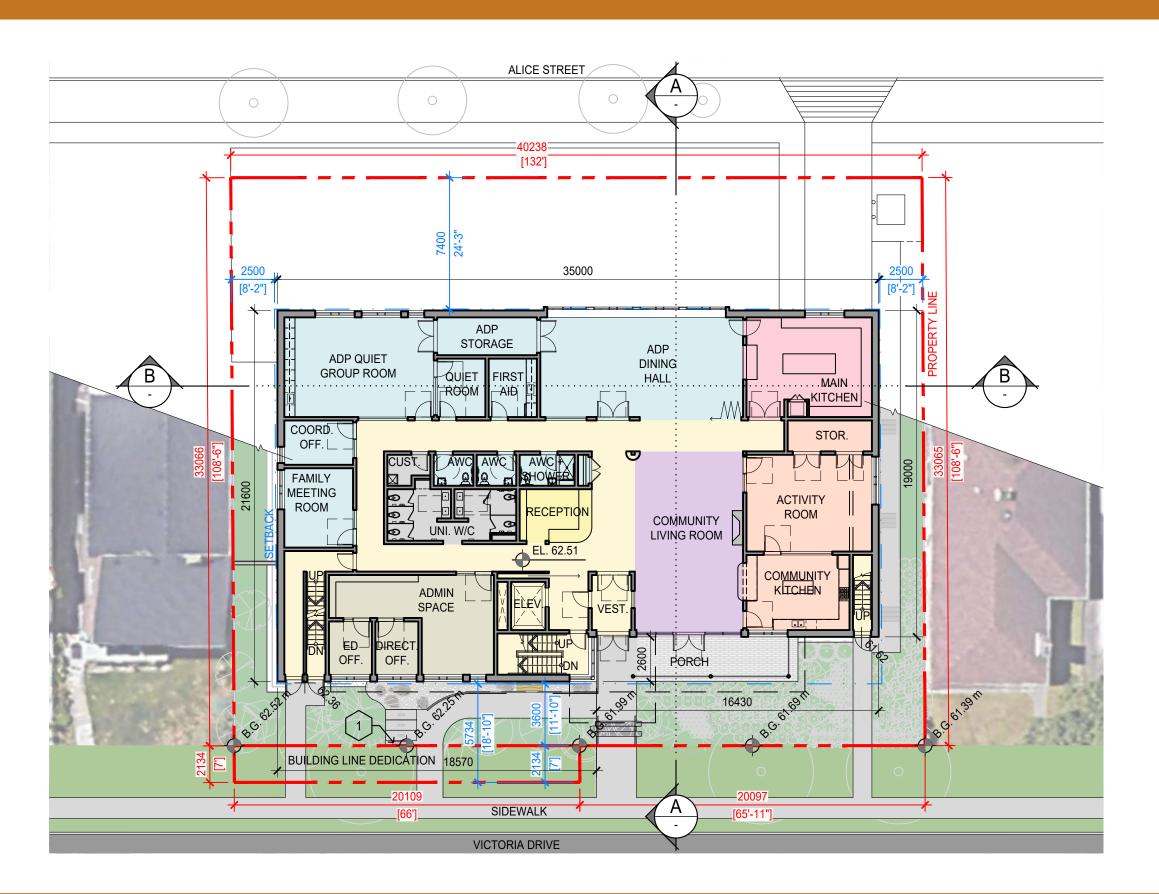

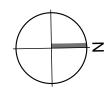


#### TDM KEYNOTES:




SUP-03: MULTIMODAL WAYFINDING SIGNAGE



# LEVEL 3 FLOOR PLAN

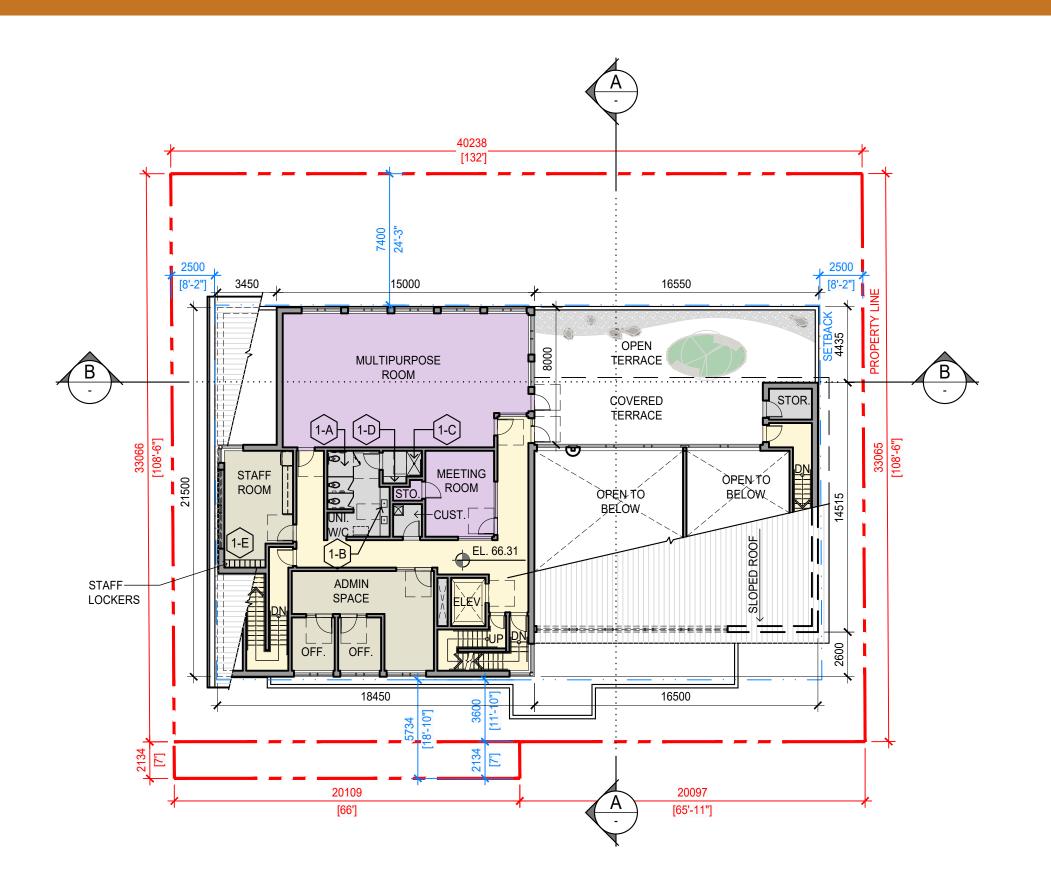

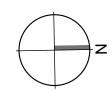

#### TDM KEYNOTES:



ACT-06: IMPROVED END OF TRIP AMENITIES

1-A: 1 WATER CLOSET 1-B: 1 WASH BASIN

1-C: 1 SHOWER


1-D: 1 GROOMING STATION FOR THE

SHOWER


1-E: 6 CLOTHING LOCKERS



# MECHANICAL PENTHOUSE LEVEL

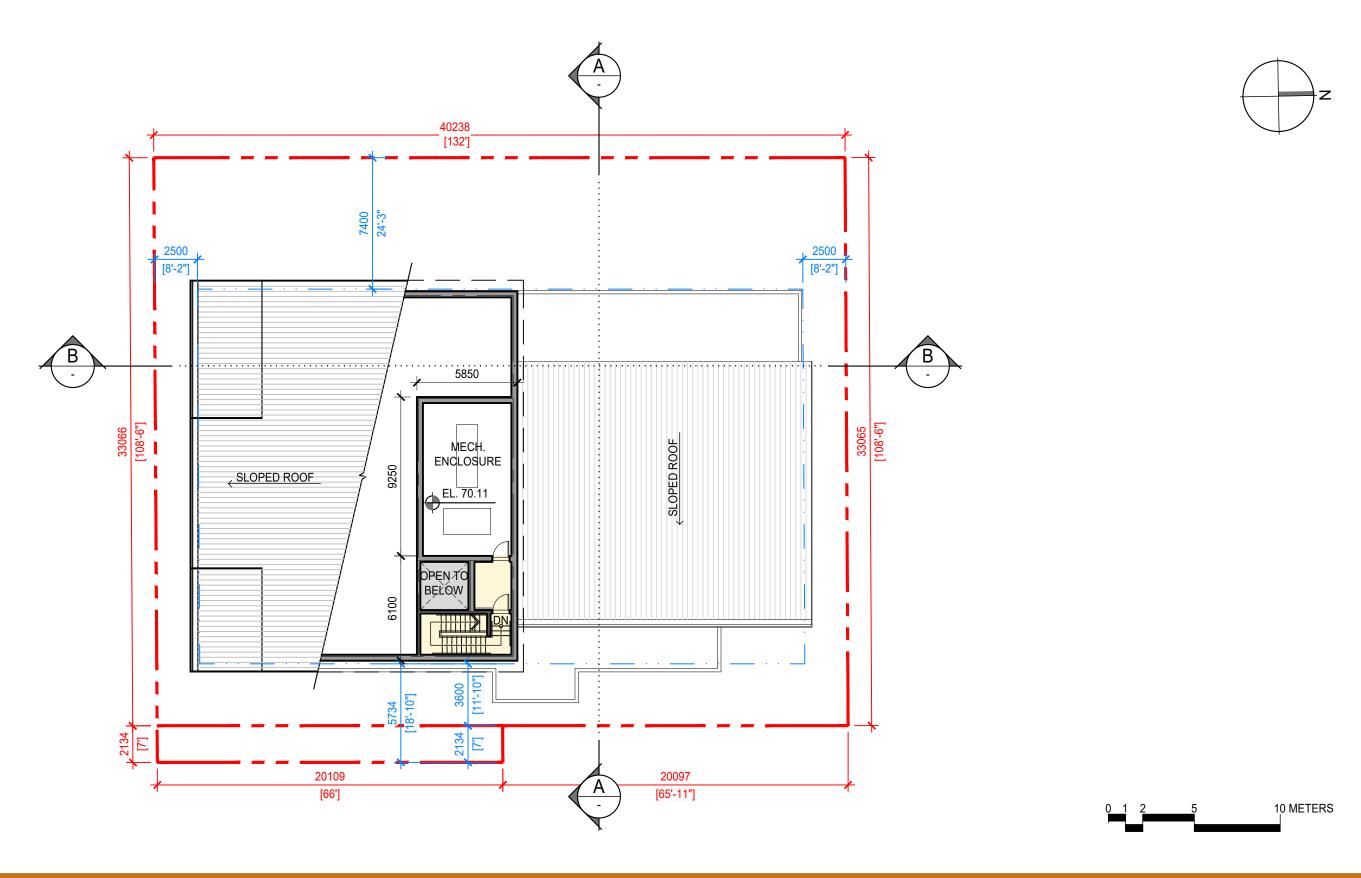


### SECTIONS

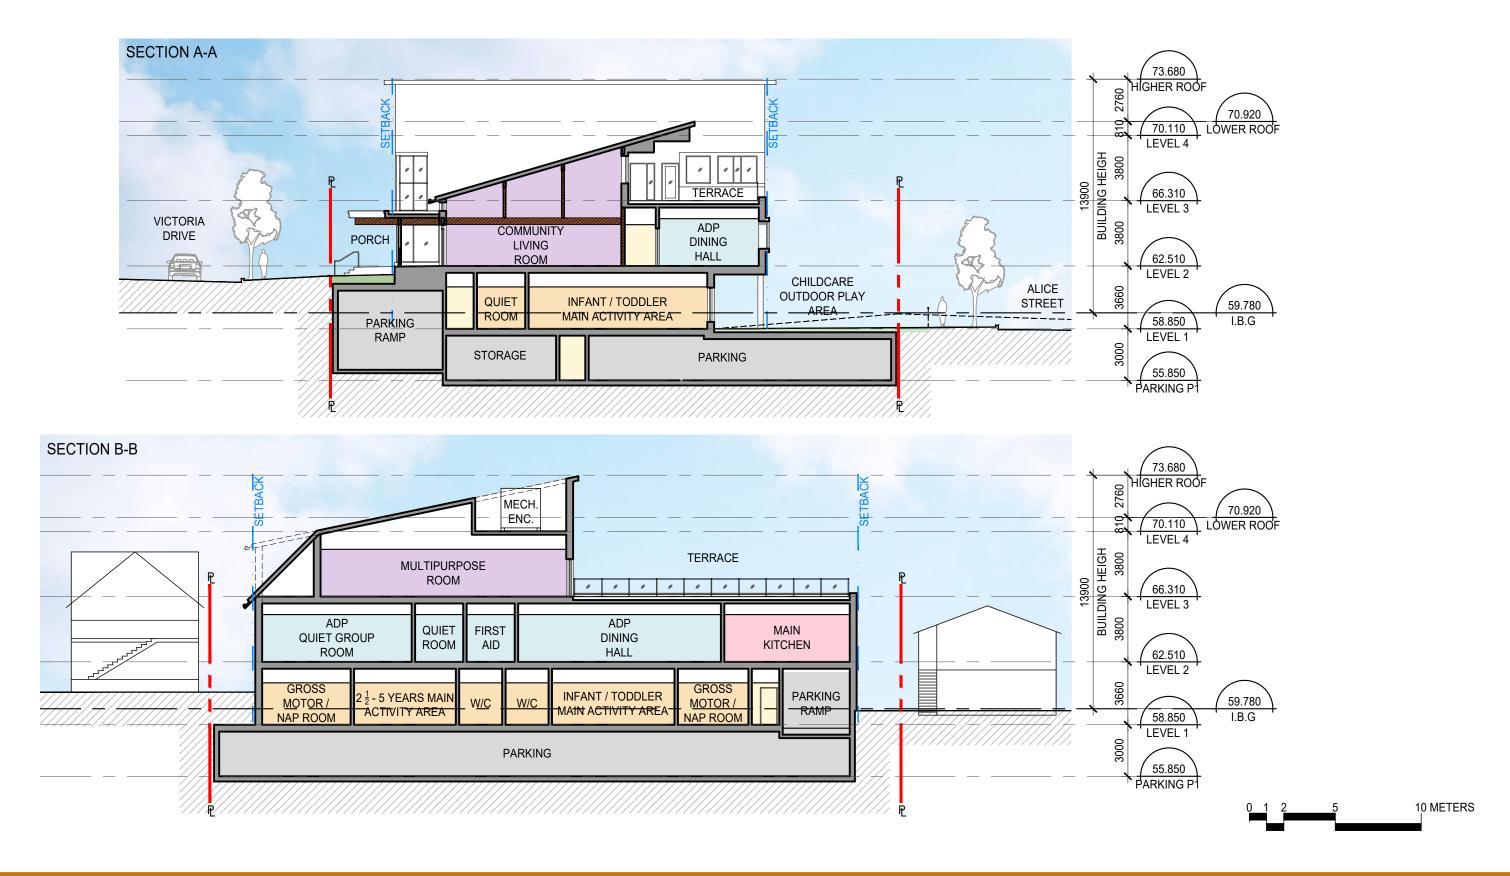

### **ELEVATIONS**



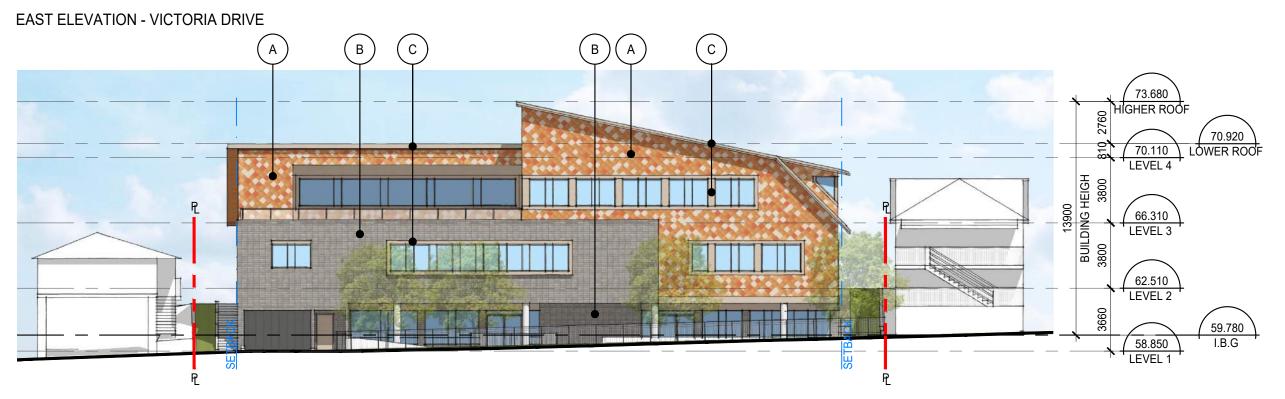


WEST ELEVATION - ALICE STREET





# **ELEVATIONS**

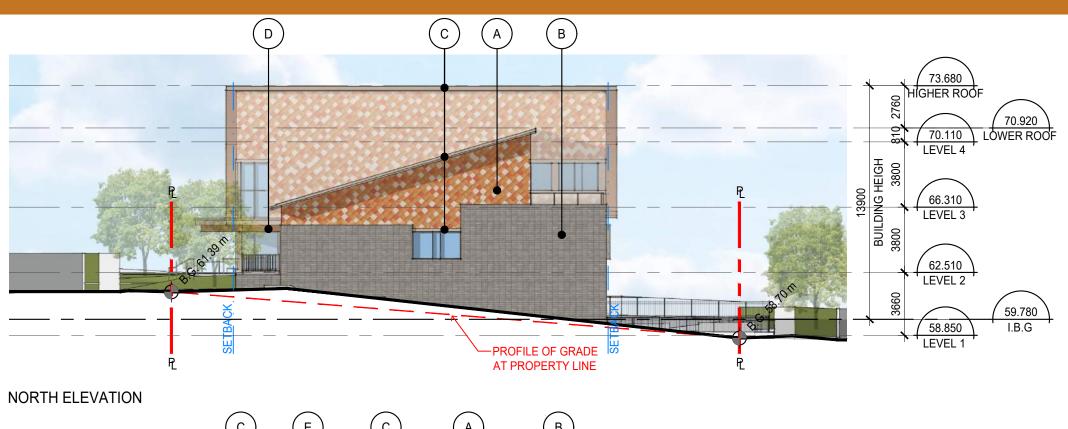

MATERIALS LEGEND


( A ) ACM SHINGLES

B STACKED BOND BRICK

C METAL TRIM

D WOOD STRUCTURE

E STANDING SEAM METAL ROOF

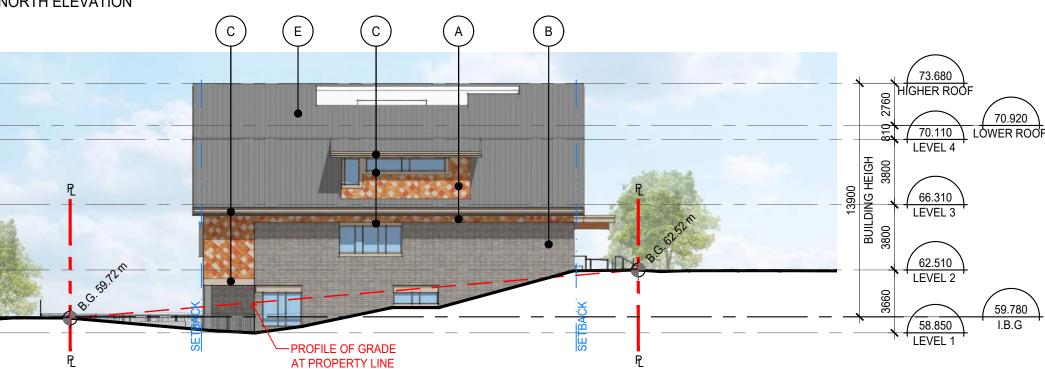


**SOUTH ELEVATION** 






# NORTH & SOUTH REFLECTED ELEVATIONS

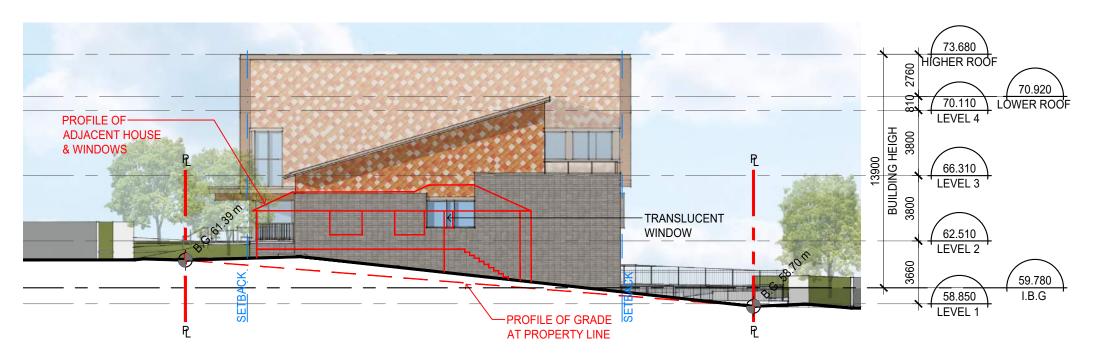

#### NORTH ELEVATION

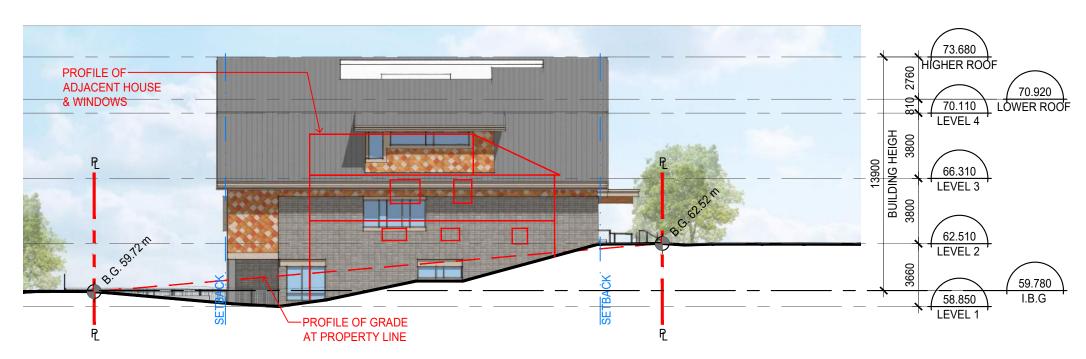

**SOUTH ELEVATION** 







# **PERSPECTIVES**



**BUILDING ENTRY AT VICTORIA DRIVE** 



LOOKING NORTHEAST ON ALICE STREET



LOOKING NORTHWEST ON VICTORIA DRIVE



LOOKING SOUTHEAST ON ALICE STREET

# PROPOSED AERIAL



LOOKING SOUTHWEST ON VICTORIA DRIVE



LOOKING NORTHEAST ON ALICE STREET

Vancouver . BC . Canada . V6J 1H4

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#### **ISSUED FOR REZONING: MAY 4, 2022**





### **CEDAR COTTAGE NEIGHBOURHOOD HOUSE**

for Association of Neighbourhood Houses, BC

Civic Address: 4065 Victoria Drive, Vancouver

#### **CONSULTANT TEAM**

OWNER: Association of Neighbourhood Houses, BC ARCHITECT: DA Architects + Planners STRUCTURAL: **ASPECT Structural Engineers** MECHANICAL: Rocky Point Engineering

ELECTRICAL: Integral Group LANDSCAPE: ETA Landscape Architecture

Cover Sheet Landscape Illustrative Plan Landscape Precedent Images Arborist Tree Management Plan L0.0 L0.1 L0.2 L0.3 L1 Detail Plan L2 Detail Plan L3 Detail Plan

L2.1 L2.2 Planting Materials Tree Planting Plan

L3.0 Soil Depth and Permeability Plan Landscape Sections and Elevation

Date Issue Notes 2022-05-04 Issue for RZ



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### **Cedar Cottage Neighbourhood House**

4065 Victoria Drive Vancouver, BC

Drawing Title

**Cover Sheet** 

Date	L0.0
Reviewed By KD	Drawing No.
Drawn By	Scale
ML	NTS
Project Manager	Project ID
KD	22205



















GATHERING SPACES EXPLORATORY PLAY




TIMBER FURNISHINGS

PACIFIC NORTHWEST PLANTING





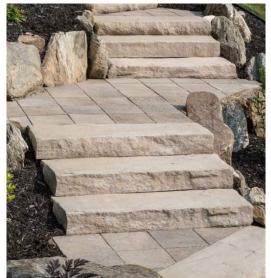

NATURAL PLAY ELEMENTS TRADITIONAL PLANT KNOWLEDGE SLAB STEPS



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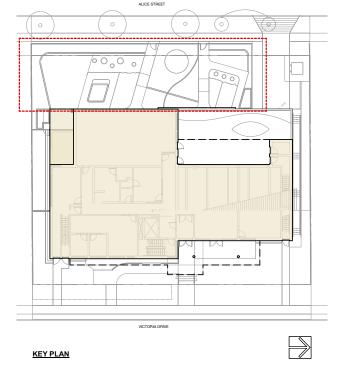
#### Cedar Cottage **Neighbourhood House**


4065 Victoria Drive Vancouver, BC

#### Landscape Precedent Images

22205
Scale NTS
Drawing No.
3





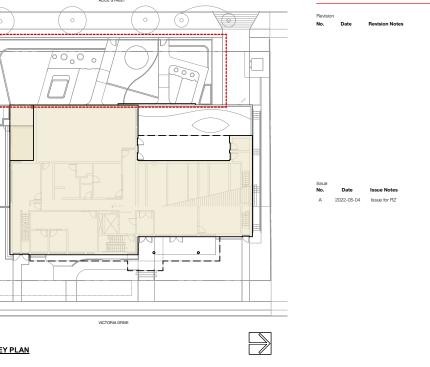
































#### **Cedar Cottage Neighbourhood House** 4065 Victoria Drive

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Vancouver, BC

L1 **Detail Plan** 

Project Manager KD	Project ID 22205
Drawn By ML	As Noted
Reviewed By KD Date	Drawing No.
	L1.1
	11



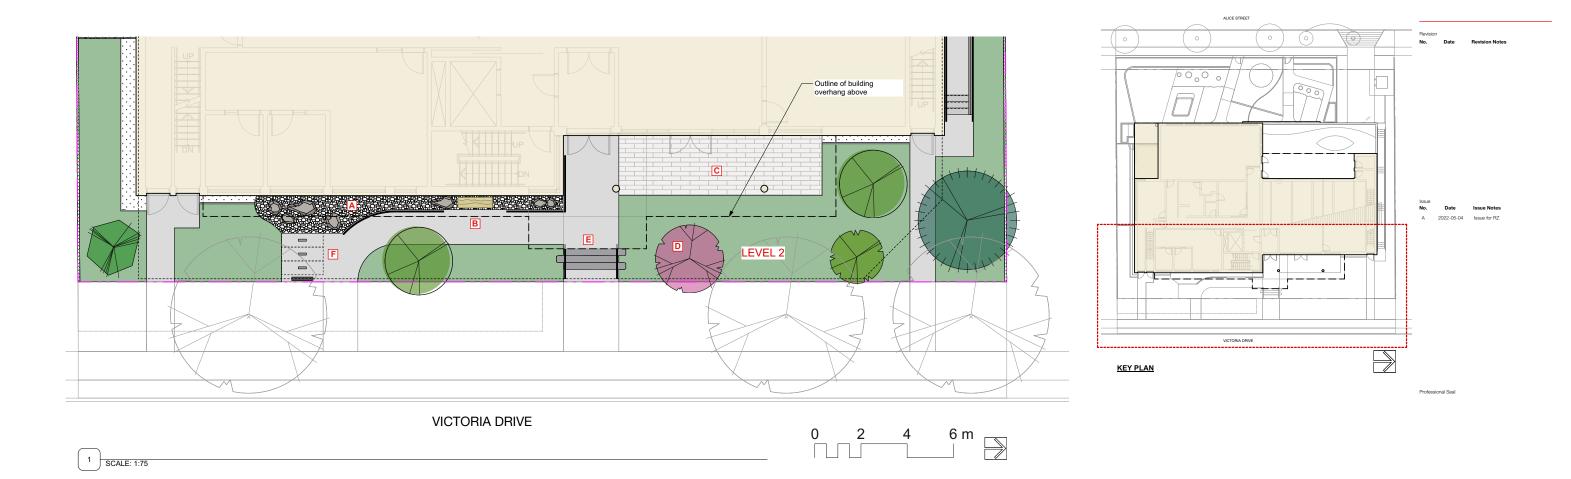



**B: BENCH ON PATH** 

### C: "WOOD" CONCRETE PAVER E: ENTRY STEPS - NATURAL STONE MATERIAL, OFFSET PLACEMENT, FEATURE LIGHTING AND PLANTING













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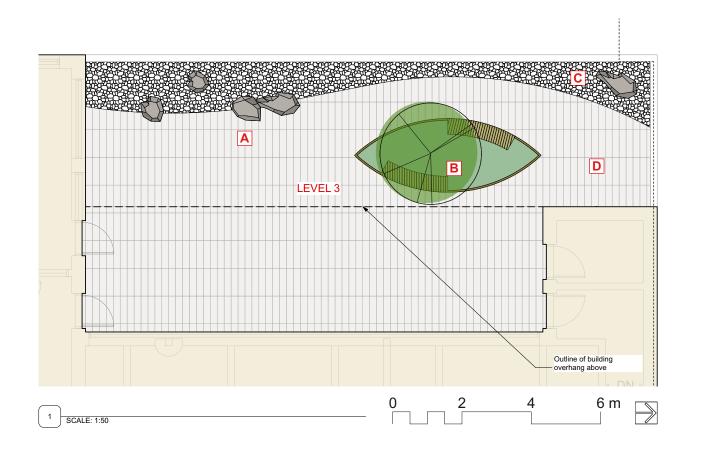
	Project Manager KD	Project ID 22205
11,7	Drawn By ML	As Noted
-1	Reviewed By KD	Drawing No.
F: BIKE RACKS x 3 (6 SPACES)	Date	6 or 11



D: FEATURE MAGNOLIA

**Detail Plan** 


eta landscape architecture




### B: FOCAL POINT - METAL PLANTER WITH INTEGRATED SEATING - REFERENCING CANOE





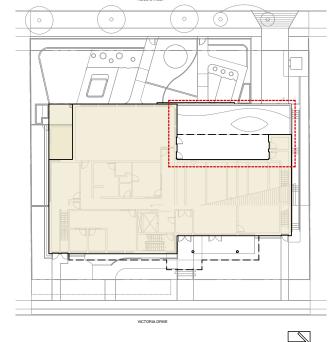

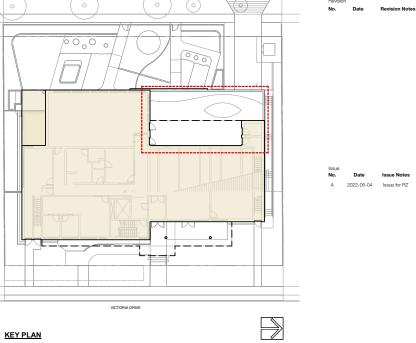

#### A: NATURAL STONE ACCENTS AND SEATING - REFERENCING LAND







#### C: RIVER ROCK BORDER - REFERENCING WATER







# D: "WOOD" CONCRETE PAVER - REFERENCING WOOD eta landscape architecture





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#### Cedar Cottage **Neighbourhood House**

4065 Victoria Drive Vancouver, BC

**Detail Plan** 

Project Manager KD	Project ID 22205
Drawn By ML	As Noted
Reviewed By KD	Drawing No.
Date	— L1.3 — 7 — 4 — 11

#### **PACIFIC NORTHWEST PLANTING**





DOUGLAS FIR



CREEPING OREGON GRAPE



SALAL **EDIBLE** 



**EDIBLE** 







SALMONBERRY

**Cedar Cottage Neighbourhood House** 

> 4065 Victoria Drive Vancouver, BC

1690 West 2nd Avenue t | 604,683,1456 f 1 604 683 1459

Drawing Title **Planting** 

**Precedent Images** 

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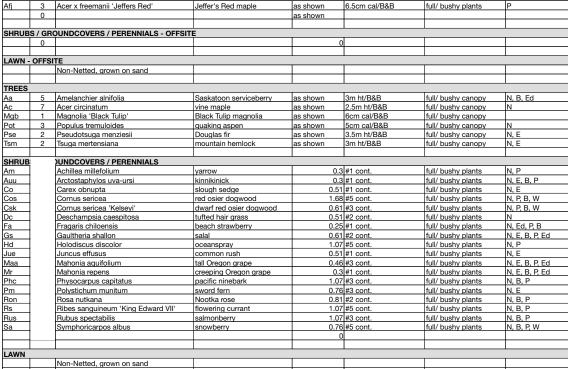
Date Issue Notes

2022-05-04 Issue for RZ

Project Manager	Project ID
KD	22205
Drawn By	Scale
ML	NTS
Reviewed By KD	Drawing No.
Date	8 8 at

# PLANT LIST ID QTY LATIN NAME

SHRUB



1 ALL LANDSCAPE TO CONFORM TO THE CURRENT EDITION OF THE CSLA STANDARDS FOR LEVEL 1 'GROOMED' LANDSCAPE TREATMENT IN THE EVENT OF A DISCREPANCY BETWEEN THE PLANT LIST AND THE PLANTING PLAN, THE PLANTING PLAN TAKES PRECEDENCE. 2 SEARCH AREA TO INCLUDE BRITISH COLUMBIA, WASHINGTON, AND OREGON P - POLLINATOR 3 N - NATIVE E - EVERGREEN B - BIRD FRIENDLY Ed - EDIBLE W - WINTER INTERES



**BEACH STRAWBERRY EDIBLE** 




**TUFTED HAIR GRASS** 







**NOOTKA ROSE** 

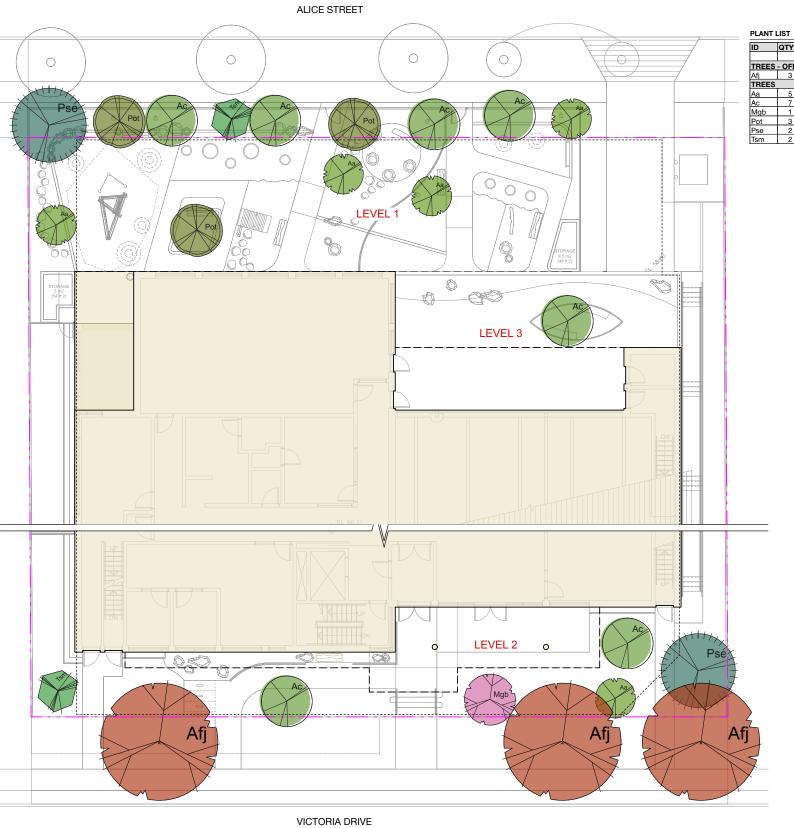

1 SCALE: 1:100

ID	QTY	LATIN NAME	COMMON NAME	SPACING	SCHEDULED SIZE	NOTES	ATTRIBUTES
TREES	- OFF-S	SITE					
Afj	3	Acer x freemanii 'Jeffers Red'	Jeffer's Red maple	as shown	6.5cm cal/B&B	full/ bushy plants	P
TREES							
Aa	5	Amelanchier alnifolia	Saskatoon serviceberry	as shown	3m ht/B&B	full/ bushy canopy	N, B, Ed
Ac	7	Acer circinatum	vine maple	as shown	2.5m ht/B&B	full/ bushy canopy	N
Mgb	1	Magnolia 'Black Tulip'	Black Tulip magnolia	as shown	6cm cal/B&B	full/ bushy canopy	
Pot	3	Populus tremuloides	quaking aspen	as shown	5cm cal/B&B	full/ bushy canopy	N
Pse	2	Pseudotsuga menziesii	Douglas fir	as shown	3.5m ht/B&B	full/ bushy canopy	N, E
Tsm	2	Tsuga mertensiana	mountain hemlock	as shown	3m ht/B&B	full/ bushy canopy	N, E

 Issue
 Date
 Issue Notes

 A
 2022-05-04
 Issue for RZ



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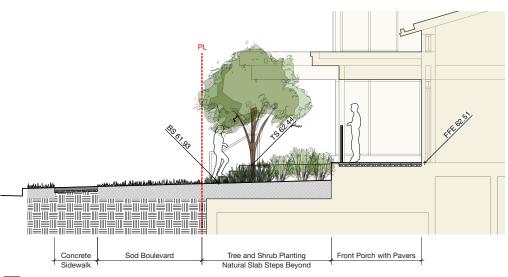
### Cedar Cottage **Neighbourhood House**

4065 Victoria Drive Vancouver, BC

Drawing Title

Tree Planting Plan


Project Manager	Project ID
KD	22205
Drawn By	Scale
ML	As Noted
Reviewed By KD Date	Crawing No.  L2.2  9  of




SECTION: L2 Frontage on Victoria Drive
SCALE: 1:50



2 SECTION: L3 Rooftop Terrace SCALE: 1:50

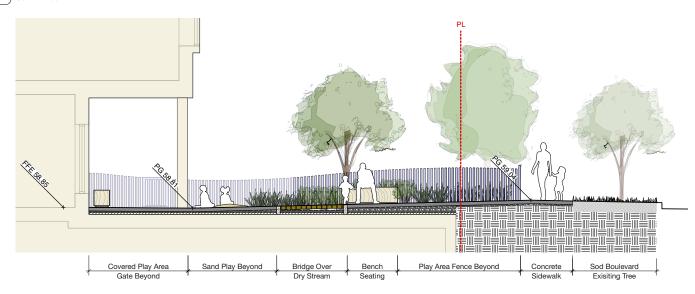

3 SECTION: L1 Outdoor Childcare SCALE: 1:50

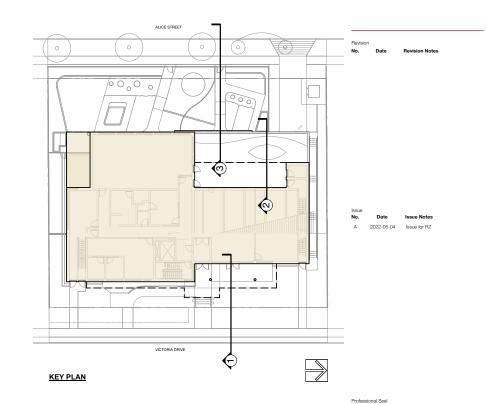

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### **Cedar Cottage Neighbourhood House**

4065 Victoria Drive Vancouver, BC

Drawing Title

#### **Landscape Sections** & Elevations

Drawn By MI	As Noted
Reviewed By KD	Drawing No.
Date	L4.0