A.6

MOTION


6. Approval of Form of Development – 3565 Sawmill Crescent

THAT the form of development for this portion of the site known as 3565 Sawmill Crescent be approved generally as illustrated in the Development Application Number DP-2021-00543, prepared by TKA+D Architecture + Design Inc., and submitted electronically on June 29, 2022, provided that the Director of Planning may impose conditions and approve design changes which would not adversely affect either the development character of the site or adjacent properties.

* * * * *

Additional Background Information:

https://wayback.archiveit.org/8849/20201029201318/https://rezoning.vancouver.ca/applications/proposedeflamendment s/index.htm

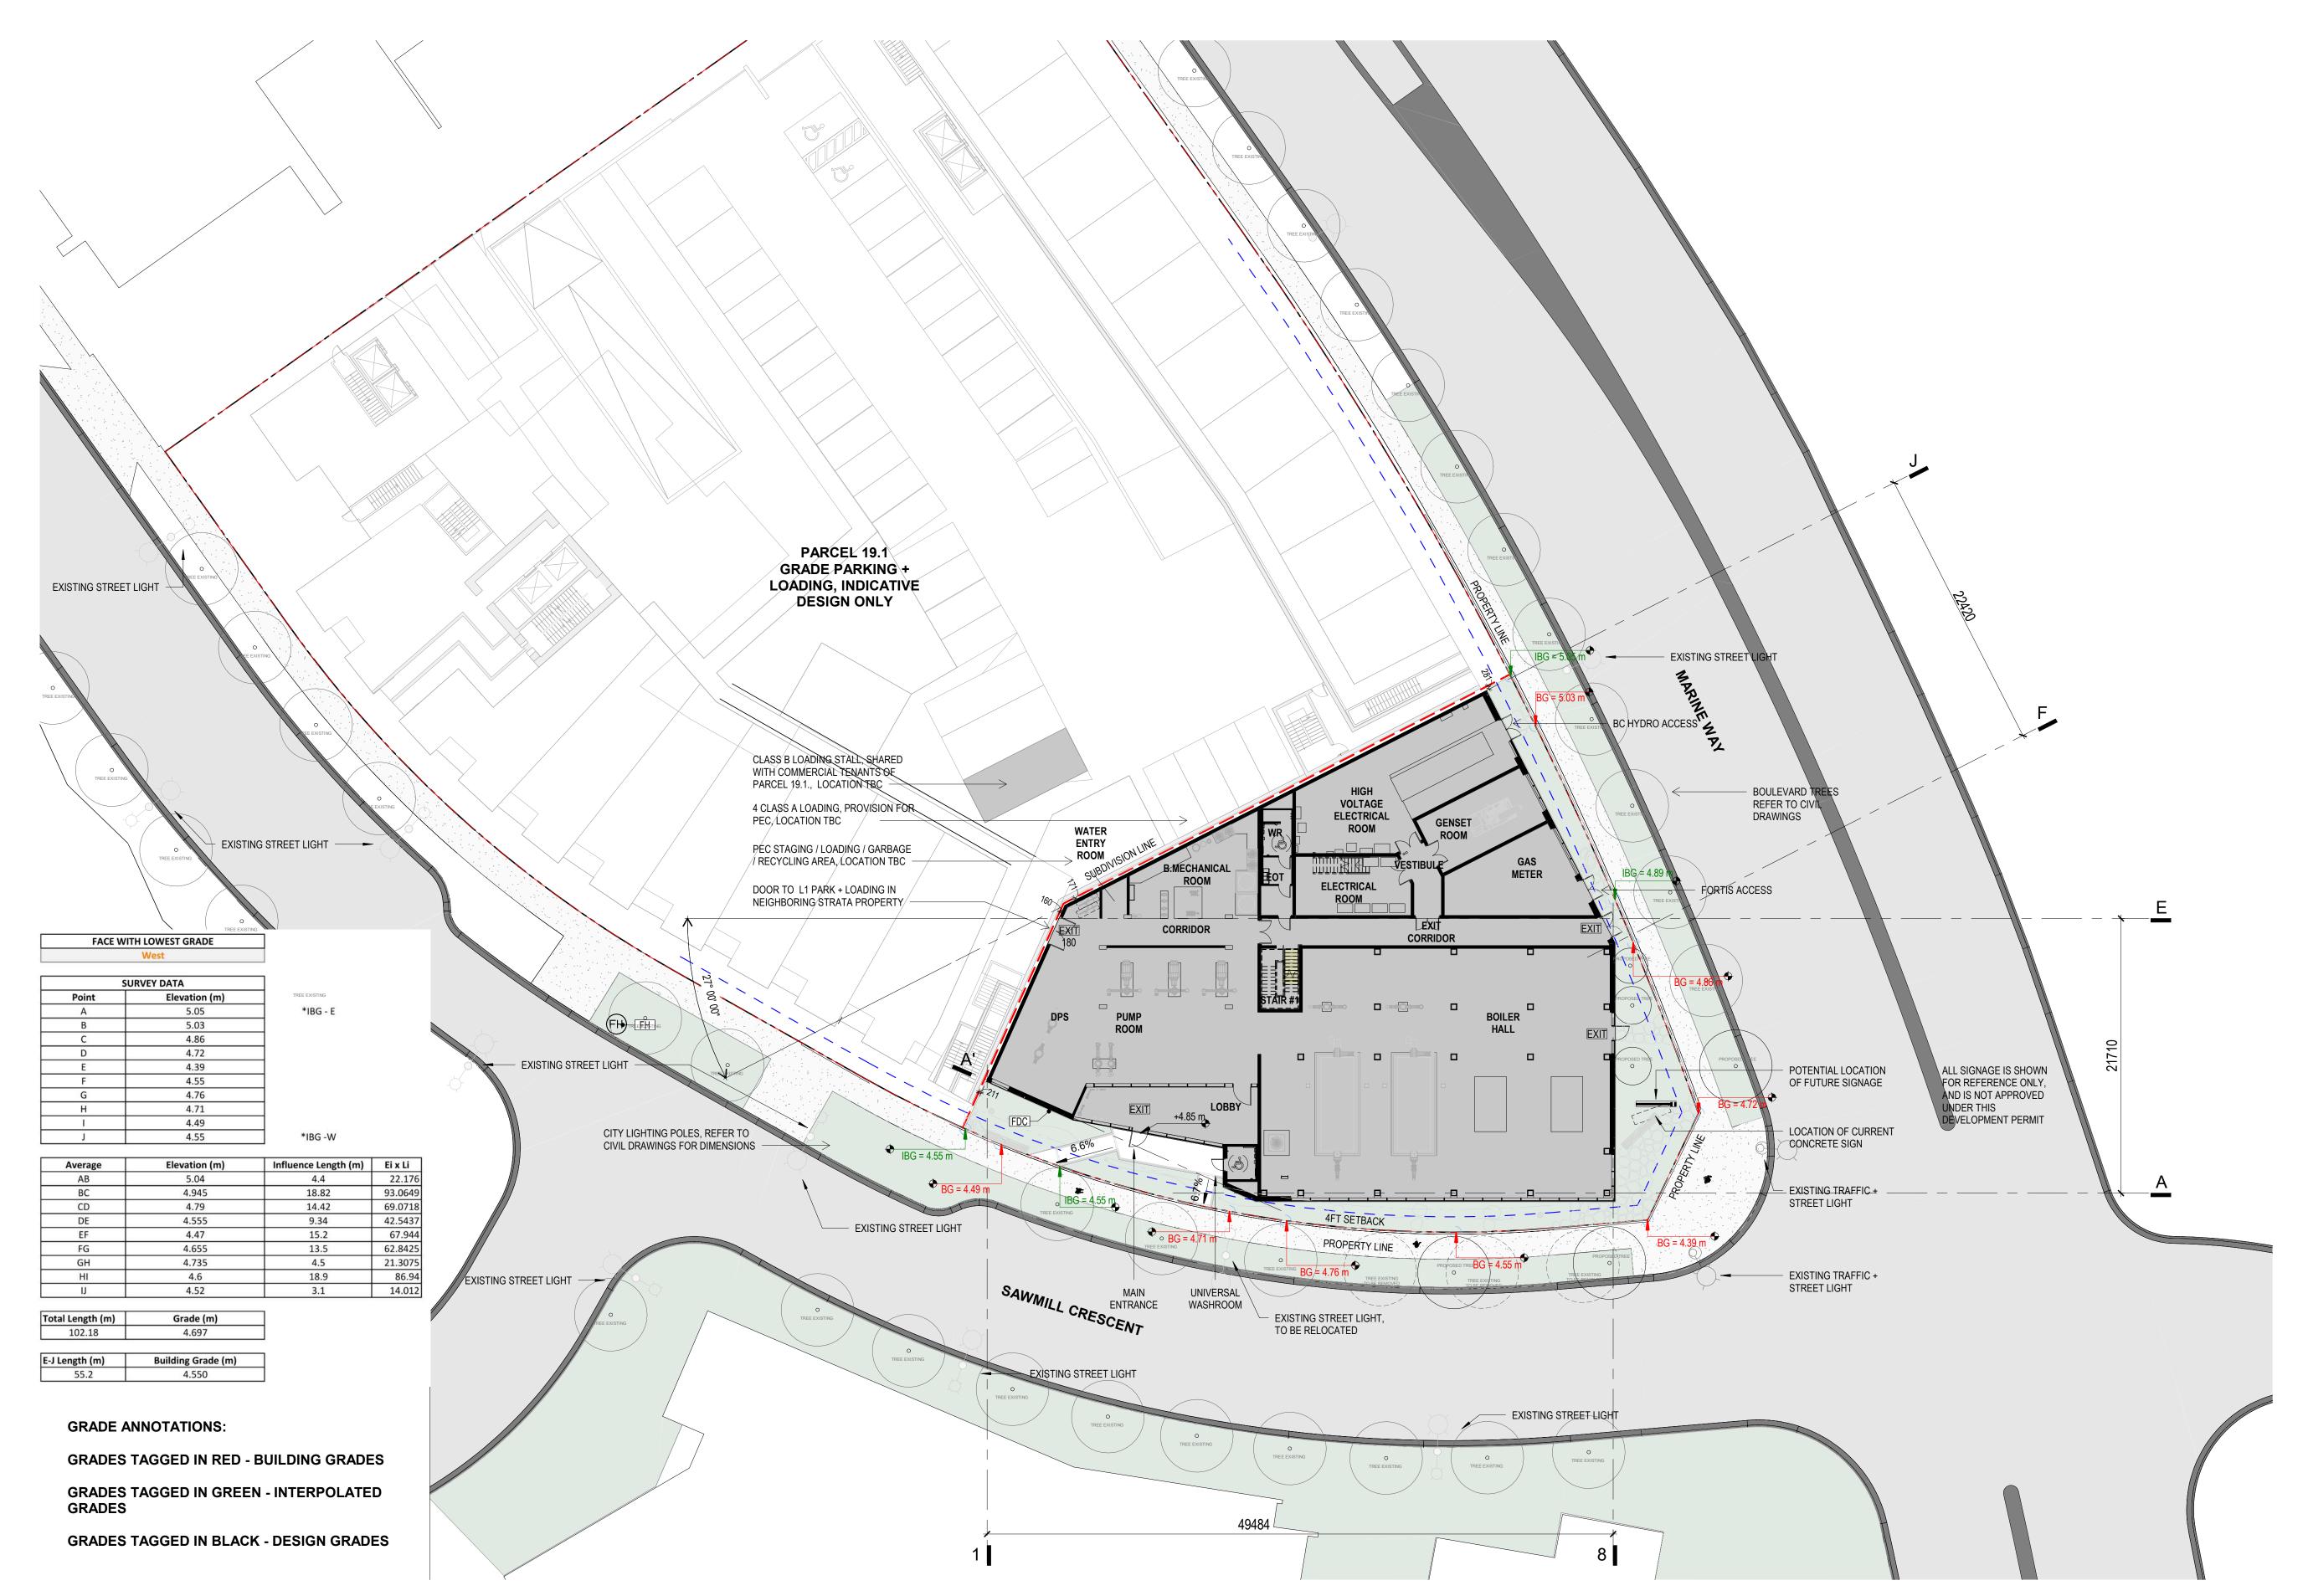



Property Area Schedule

Parcel 19 PL 7146 m² 1.77 acres
Parcel 19.2
Setback

ALL BUILDING DIMENSIONS, SETBACKS AND YARDS ARE TO THE OUTSIDE OF CLADDING.

5 TREES IDENTIFIED ON PLAN TO BE REMOVED TO FACILITATE ACCESS FOR MECHANICAL EQUIPMENT INSTALLATION, MAINTENANCE AND REPLACEMENT.

1 STREETLIGHT IDENTIFIED ON PLAN TO BE RELOCATED TO ACCOMODATE METROVAN INCOMING PIPES BELOW GRADE

1 2021/06/22 ISSUED FOR DEVELOPMENT PERMIT

REV DATE DESCRIPTION

SCALE: 1:250 DATE: JUNE 10 2022 DRAWN: Author

PROJECT NUMBER

FILE C:\Users\Luciano\Documents\River District PLOT
PATH: Energy_Current_R22_20030_LucianoAAQAV.rvt DATE: 6/15/2022 11:37:52 AM

WESGROUP

TKA+D A R C H I T E C T U R E + D E S I G N I N C 305 - 1930 PANDORA STREET . VANCOUVER . V5L 0C7 . P 604 569 3499

River District Energy Plot 19.2, 3565 Sawmill Crescent, Vancouver, BC

Site Plan

A100






ALL BUILDING DIMENSIONS, SETBACKS AND YARDS ARE TO THE OUTSIDE OF CLADDING.

Keynote Legend - Legend	
Key Value	Keynote Text
2SSG	2 SIDED STRUCTURAL GLAZING
ACM	ALUMINUM METAL COMPOSITE
CHK	COAT HOOK
CMP1	COMPOSITE METAL PANEL - TYPE 1
FDC	FIRE DEPARTMENT CONNECTION
FH	FIRE HYDRANT
GB1	GRAB BAR - TYPE 1
GB2	GRAB BAR - TYPE 2
GL1	GLAZING - TYPE 1
HD	HAND DRYER
MC-1	METAL CLADDING - 1
MC-2	METAL CLADDING - 2
MIR1	MIRROR - Type 1
ML	METAL LOUVERS
RAH	ROOF ACCESS HATCH
RD	ROOF DRAIN
RLH	ROOF LADDER TO HATCH
SHR	SHOWER
SHRH	SHOWER HEAD
SMC	STANDING SEAM METAL CLADDING
SNDD	SANITARY NAPKIN DISPOSAL UNIT
SNK	SINK
SOAP	SOAP DISPENSER
SSH	SUNSHADE
TPH	TOILET PAPER HOLDER

WATER CLOSET

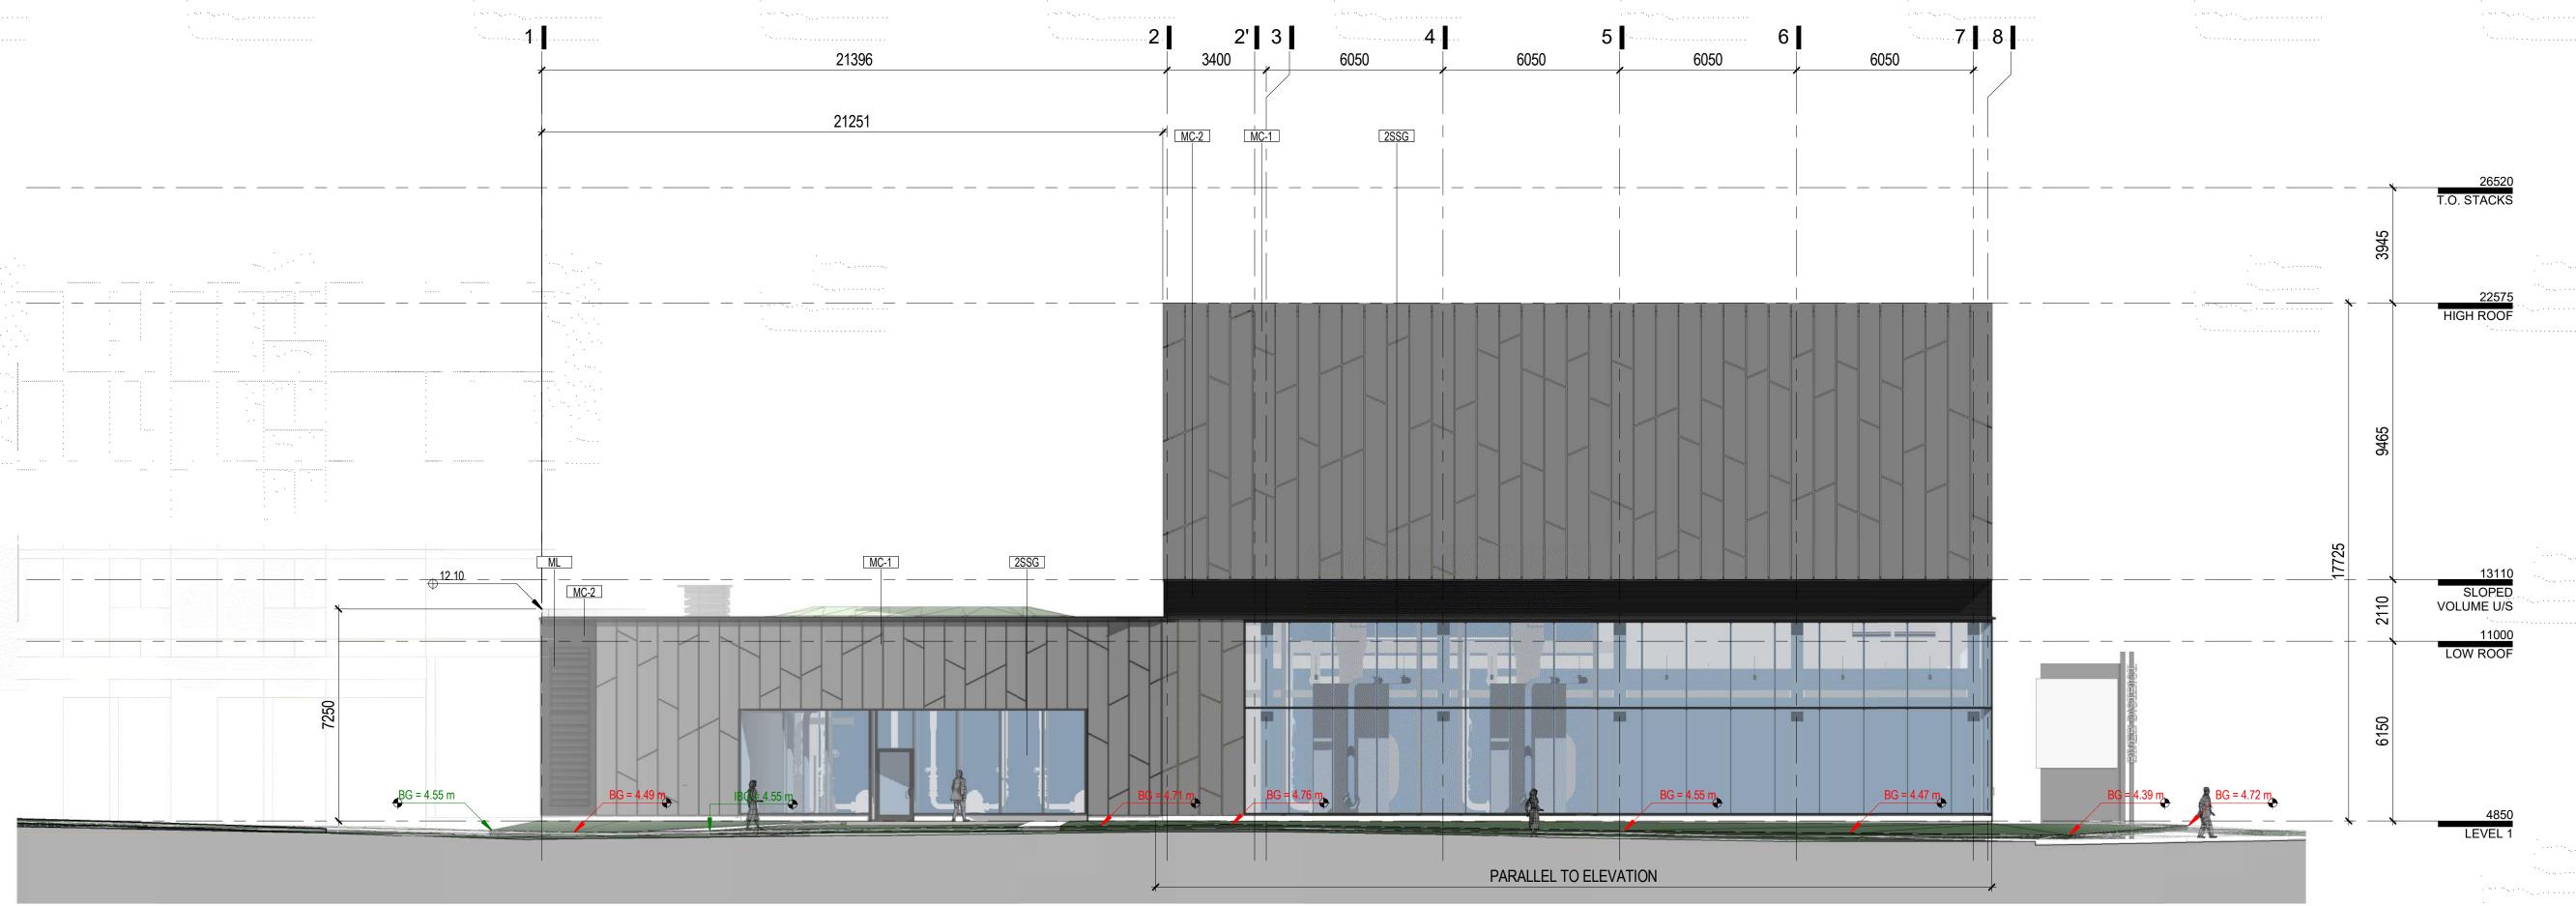

1 Elevation South - Parallel to Boiler Hall 1: 125

1'



Elevation South - Parallel to Lobby 1: 125

A300



Keynote Legend - Legend

COAT HOOK

FIRE HYDRANT GRAB BAR - TYPE 1

HAND DRYER

ROOF DRAIN

SOAP DISPENSER SUNSHADE

WATER CLOSET

TOILET PAPER HOLDER

SHOWER SHOWER HEAD

ROOF LADDER TO HATCH

STANDING SEAM METAL CLADDING

SANITARY NAPKIN DISPOSAL UNIT

GRAB BAR - TYPE 2 GLAZING - TYPE 1

METAL CLADDING - 1 METAL CLADDING - 2 MIRROR - Type 1 METAL LOUVERS ROOF ACCESS HATCH

Keynote Text

2 SIDED STRUCTURAL GLAZING

ALUMINUM METAL COMPOSITE

COMPOSITE METAL PANEL - TYPE 1

FIRE DEPARTMENT CONNECTION

