A.1

MOTION


1. Approval of Form of Development – 5035 Boundary Road

THAT the form of development for this portion of the site known as 5035 Boundary Road (formerly known as 5003 -5399 Boundary Road) be approved generally as illustrated in the Development Application Number DB-2019-05250 prepared by MBD Maple Building Design Inc., and stamped "Received, Community Services Group, Development Services", on December 4, 2019, provided that the Director of Planning may impose conditions and approve design changes which would not adversely affect either the development character of the site or adjacent properties.

* * * * *


Additional Background Information:

No link is available for this rezoning application.

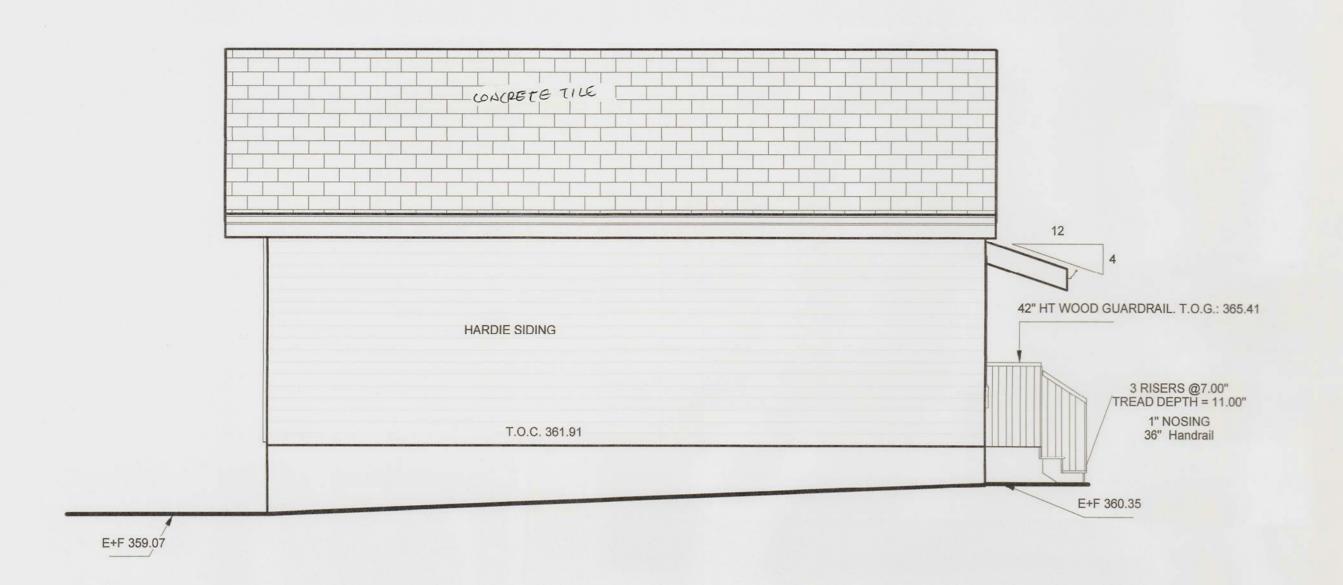



South (Left) Elevation

1/4" = 1'-0"

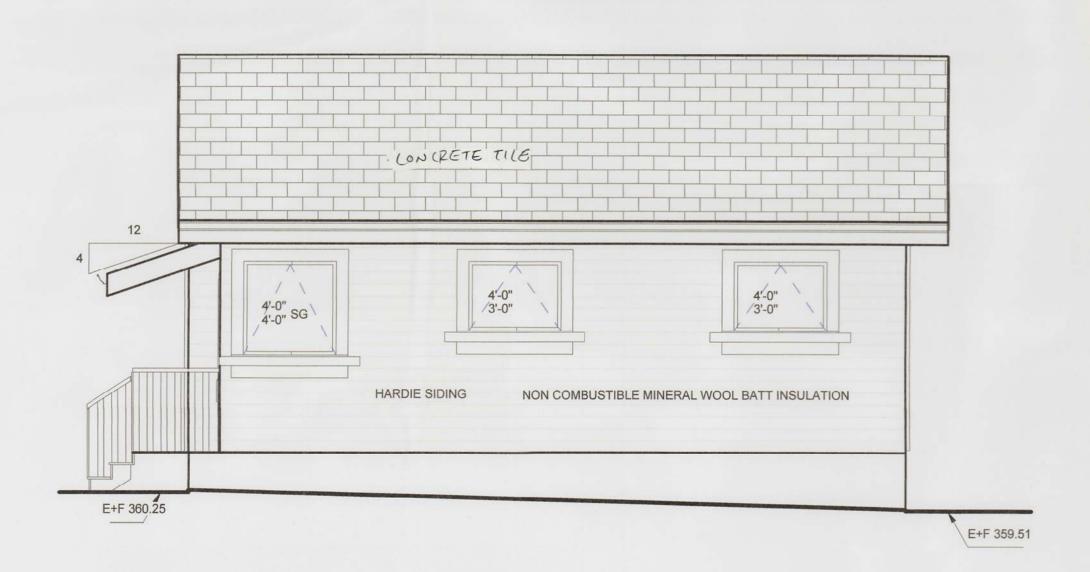

LIMITING DISTANCE = 4'6.5" EXPOSED WALL AREA = 320 SF ALLOWABLE UNPROTECTED AREA = 320 SF X 8% X 2 (SPRINKLERED) = 50 SF PROPOSED UNPROTECTED AREA = 40

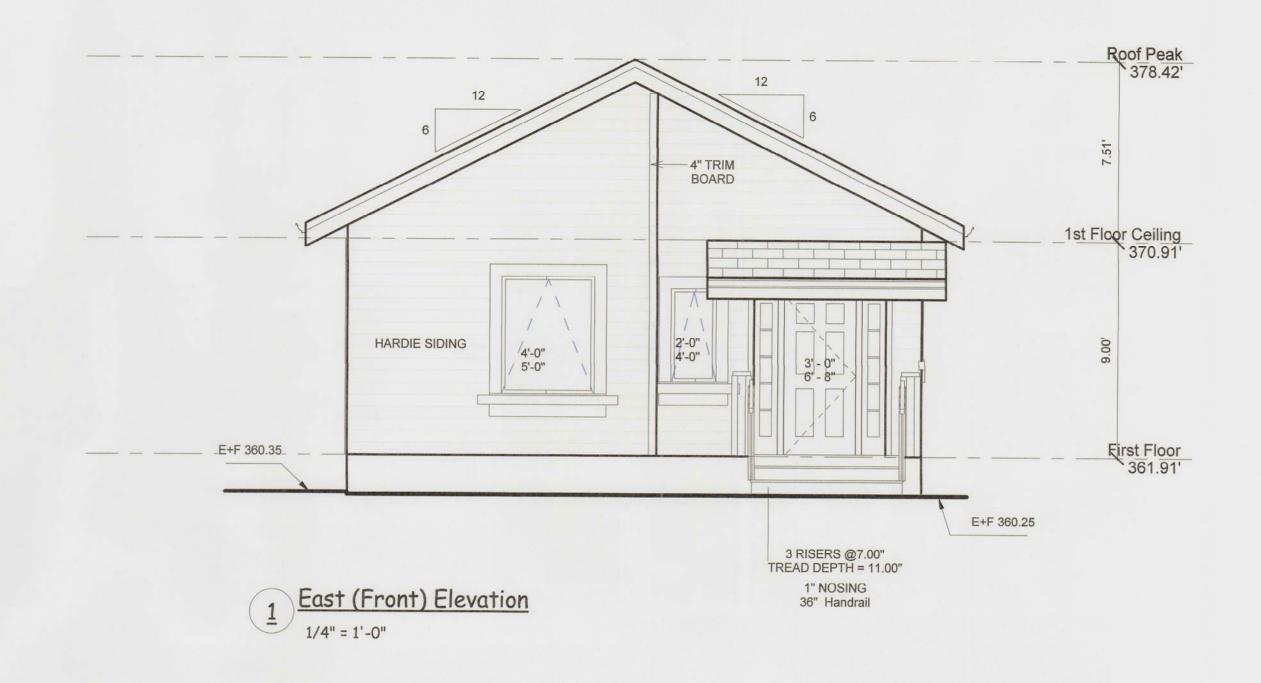

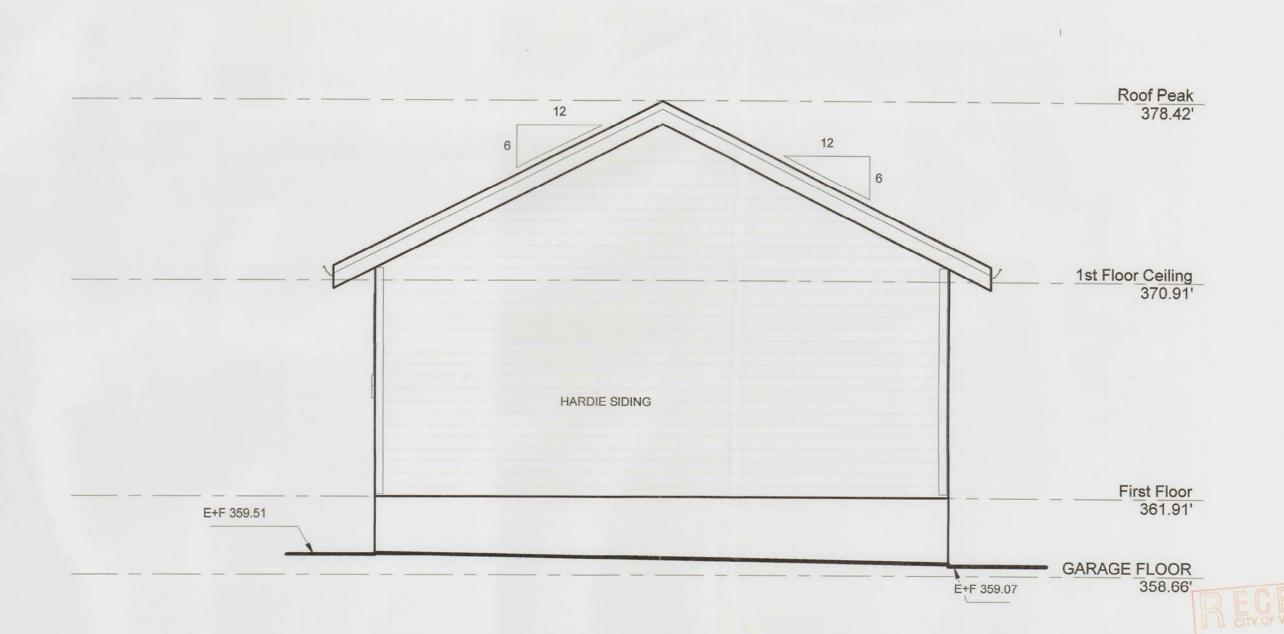


West (Rear) Elevation

1/4" = 1'-0"





1/4" = 1'-0"

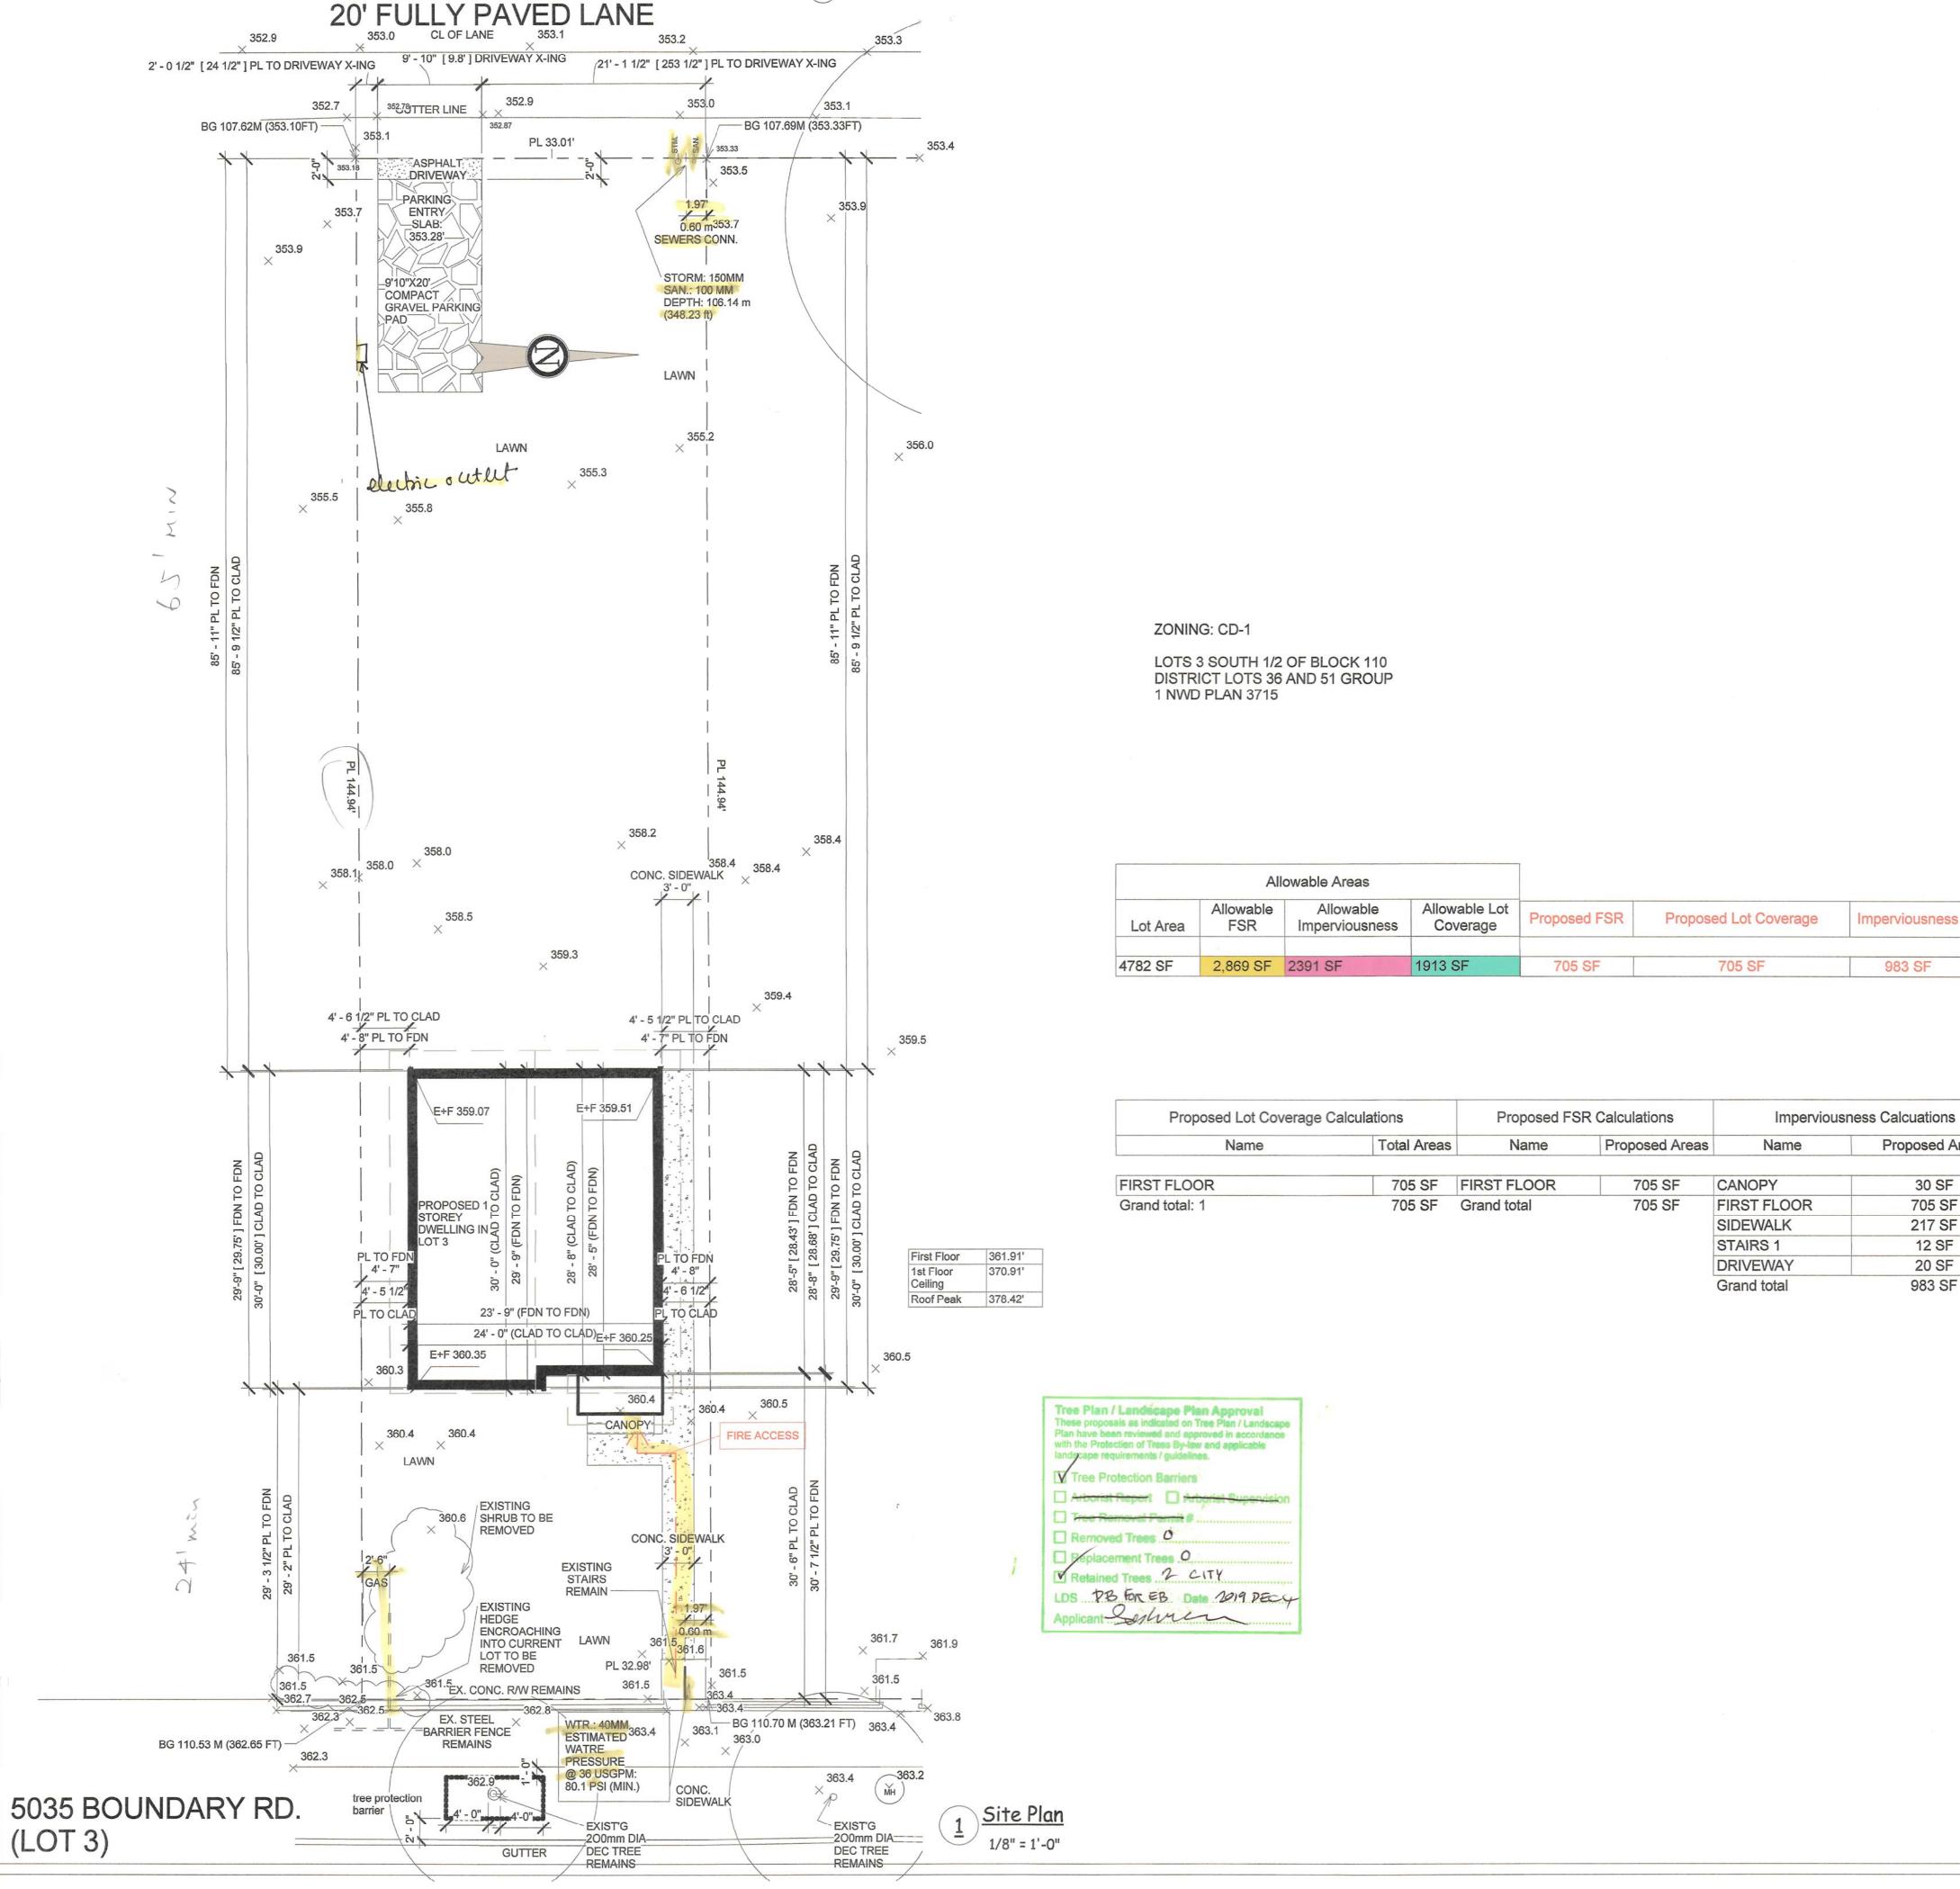

352.9 ×

5035 Boundary DB-2019-05250

Allowable Aleas						
Lot Area	Allowable FSR	Allowable Imperviousness	Allowable Lot Coverage	Proposed FSR	Proposed Lot Coverage	Imperviousness
4782 SF	2,869 SF	2391 SF	1913 SF	705 SF	705 SF	983 SF

Proposed Lot Coverage Calculations		Proposed FSR Calculations		Imperviousness Calcuations	
Name	Total Areas	Name	Proposed Areas	Name	Proposed Areas
FIRST FLOOR	705 SF	FIRST FLOOR	705 SF	CANOPY	30 SF
Grand total: 1	705 SF (Grand total	705 SF	FIRST FLOOR	705 SF
				SIDEWALK	217 SF
				STAIRS 1	12 SF
				DRIVEWAY	20 SF
				Grand total	083 SE

PUBLIC SEWER AND WATER CONNECTION INFORMATION

SEWER INFORMATION FOR 5035 BOUNDARY RD., VANCOUVER (LOT 3, MAIN HOUSE) THIS SITTE PLAN SHOWS THE LOCATIONS, SIZES AND INVERT ELEVATIONS OF THE PUBLIC STORM AND SANITARY SEWER CONNECTIONS.

PLUMBING FIXTURES ARE RESTRICTED AS FOLLOWS: (CLASS II) A) PUMP ALL SANITARY FIXTURES (INCLUDING FLOOR DRAINS) WITH RIM ELEVATIONS

BELOW 107.66 m (geodetic) or 353.215 ft (geodatic), AND

B) IF THE LOWEST FLOOR SLAB OR THE LOWEST OUTSIDE STORM DRAIN IS BELOW THE SANITARY FIXTURE RESTRICTION ELEVATION NOTED IN "A" ABOVE, THEN: 1) PUMP ALL STORM FIXTURES BELOW THE RESTRICTED ELEVATION, OR

2) CONNECT ALL ROOF DRAINS AND STORM FIXTURES WITH RIM ELEVATIONS ABOVE THE RESTRICTED ELEVATIONS THROUGH ONE SUMP AND CONNECT THE SUBSOIL DRAINAGE SYSTEM(DRAIN TILES) AND ALL STORMWATER FIXTURES WITH RIM ELEVATIONS BELOW THE RESTRICTED ELEVATIONS TO A SECOND SUMP(SEE SCHEMATIC DRAINGS FOR CLASS 2 FISTURES RESTRICTIONS)

WATER INFORMATION

THE ESTIMATED WATER PRESSURES @36 U.S. GPM FOR THIS SITE ARE:

WINTER STATIC: psi STATIC: 80.1 psi RESIDUAL: psi

NOTES

The City of Vancover does not guarantee the accuracy of the information provided on this Plan. Circumstances may prevent the City from installing the public sewer and/or water connections at the locations and depths shown on this Plan.

The Owner is respirable for locating and connecting to the public sewer and water connections installed by the City regardless of their actual installed locations and depths. The Owner is respinsible for ensuring that the sizing of the private plumbing system is adequate for the storm & sanitary sewer discharges and the domestic & fire water flows, No person shall cornect a building sewer or water system to a public connection without first obtaining a "Public Sewer & Water Connection Permit".

All mylisions related to the sewer and water information on this site plan must have Engineering review and acceptance prior to making the change(s). Any requests for changes after a City crew has arrived at the site may cause installation delays and additional costs.

FIXTURE RESTRICTION PUMPING REQUIREMENTS

Datum In: (CHECKONE) Geodatic					
CHECK ONE) R	Fixture Type (eg. shower, tollet, sink, patio drain, stairwell drain, etc) (A)	Rim Elevation +(B)	Fixture Restriction Elevation (See "Sewer Information") (C)	Pumping Requirements ² (if B is than C circle "Yes" otherwise circ "No") (D)	
Floor Drain with the lowest rim elevation in the building	Floor Drain ²	361.91 ft	353.215 ft	(Yes) No	
Sanitary Fixture (excluding floor drains) with the lowest rim deviation in the building	TOILET	362.16 ft	353.215 ft	(Yes)/ No	
Storm Fixture with the lowest rim elevation outside the building	DRAIN TILE	360.41 ft	353.215 ft	(Yes) No	

The rim illevation is the elevation which a future will start to overflow onto the floor /ground (e.g. rim of shower tall, top of bathtub, rim of toilet bowl, top of sink, top edge of floor drain .. etc). Building Floor drains must connect to the sanitary system.

3. Pump all firitures with rim elevations below the restricted elevation. All other fixtures that can flow by gravity to the public sewer connection must flow by gravity and not by pumped.

DEC 0 4 2019 DEVELOPMENT SERVICES

MBD Maple Building Design Inc. Builder / Owner: RAI DEVELOPMENT 604-771-7477 6608 Main Street, Vancouver, BC V5X 3H2 Canada Tel.: 604-323-2572 Fax.: 604-324-2572

e-mail: info@mbdbc.com

www.mbdbc.com

www.maplebuildingdesign.com

Site Plan 3 DEC., 2019 Date Drawn by DRAWING NO. 1 of 6

Site Address: 5035 (LOT 3) Boundary Rd., Vancouver, BC

1/8" = 1'-0"

GL

