4-STOREY SECURED	MARKET	RENTAL	HOUSING
4506 RUPERT ST	REET, VA	NCOUVE	R, BC





MATTHEW CHENG ARCHITECT INC.

Unit 202 - 670 EVANS AVENUE VANCOUVER, BC V6A 2K9 Tel: (604) 731-3021 / Cel: (604) 649-0669 Email: matthew@mcai.ca

THIS DRAWING MUST NOT BE SCALED. THE GENERAL CONTRACTOR SHALL VERIFY ALL DIMENSIONS AND LEVELS PRIOR TO COMMENCEMENT TO WORK. ALL ERRORS AND OMISSIONS SHALL BE REPORTED IMMEDIATELY TO THE ARCHITECT. COPYRIGHT RESERVED. THIS PLAN AND DESIGN ARE AND AT ALL TIMES REMAIN THE EXCLUSIVE PROPERTY OF MATTHEW CHENG ARCHITECT INC. AND MAY NOT BE USE OR REPRODUCED WITHOUT PRIOR WRITTEN CONSENT.

4506 Rupert St. Vancouver BC

Sheet Title COVER

rawn: HF	R	
hecked:MC	;	
cale:		

Print Date: 02262018

A101



2' (0.6 m)	
2' (0.6 m)	
2' (0.6 m) /12' (3.7m)	
12'	
12' (3.66 m) to 30' (9.1 m)	
13.72 m	
Provided	
22	
2(4)	
-(.,	
_	
7	
4(5)	
1(5)	
38	Company of the Compan
50	1
42	
B1-III-I	
Residential	1
3291.76	
1847.32 8331.69	
	1000
8368.92 5989.12	17.7
2546.78	
2546.78	
1730.30	
34515.65	
3206.61	May .
M2	1

3704.95

4506 Rupert St., 3309 Price St. LOT 1, 2, AND 7, PLAN 7903 AND LOT A (REFERENCE PLAN 2155) PLAN 849, ALL

OF BLOCK 96, DISTRICT LOT 36 AND 51, GROUP 1, NWD

15963.71

26606.18

155.40 2837.99

Proposed CD (Rental 100)

sf

18671.00

2.14

39879.76

5364.11

34515.65

Required

C-1, RS-1

sf

18671.00

1.2 + 0.7 = 1.9

35474.90

12.14' (3.7m)

0

5' (1.5 m)

9.2m-10.7m

Required 1 per 125 m2 of gross floor area plus 0.075 per

unit= 28.9

Res: 1+0.034x42=1.36=2.36

1 per 100 m2 of gross floor area up to 300 m2, 1 $\,$ additional per 50 m2 after 513.53 m2 = 7

0.075 x 42=3.15

1=5

1.25 x 40 =50 42

Commercial: 1

Commercial

3857.62

1506.49

5364.11

498.34 SF

39879.76

0.45

0.75

3.7m2 per dwelling unit

Site Address

Legal Address

Existing Zoning

Buildable area

Residential Storage

Side, East (Adjoin lane)

Side, East (Adjoin Price)

Building Height

Residential

Handicapped

Parking Calculation

Commercial Parking

LEVEL

1 Mezzanin

1 Townhouse

2 Townhouse

3 Townhouse

Total

Total R & C

Visitor parking CarShare

Total **Bick Storage**

Storage

Loading

Open and enclosed balconies

Commercial

Residential

Setback Front Yard E 29 Ave Rupert St Price St

Side yard

Site Area

Rezoning Rationale

SITE DESCRIPTION

The application is prepared in order to rezone the site from C1-RS1 to CD (Rental 100). The proposal is to build a residential and commercial 4-storey + basement building .The building includes: 4 grade-oriented loft units, 8 stacked townhouses, and 30 units (1, 2, and 3 bedroom). The development is 100% rental housing, secured by a non-stratification convenant for a 60-year tenure. 35% of the rental units will be suitable for families (2-bedroom and 3-bedroom). The project is on an arterial road surrounding by E 29th Avenue, Rupert Street, and Price Street, at a location designated as a "Local Shopping Area". It has immediate proximity to public transit, situated along bus route # 027, within 900 meters of the Joyce- Collingwood Skytrain Station. It is also immediately adjacent to Sir Wilfred General Elementary School. The site area is 1734.59 m2 (18671 sf), and we propose a target FSR of 2.13, for a proposed buildable area of 3781.41 m2 (39879.76 sf).

NEIGHBOURHOOD

The site is located in commercial zone at the intersection of Rupert St and East 29th Avenue.

It is flanked to the east by an established residential area, and to the south by Sir Wilfred Grenfell Elementry School.

TRANSIT ORIENTATION

The site is located within walking and biking distance to a number of transit modes. The Joyce Skytrain Station is located within a 10-minute walk or a3-minute bike ride from the site,

and a bus rout passes directly adjacent to the site

Rupert Street, East 29 Avenue

Distance from site less than 1 block

Transit Available Bus 027
Joyce Street, BC Parkway (Joyce Station)

Distance from site 4 blocks

Skytrain Expo Line, Millenum Line Buses 026, 027, 028, 041, 043

BACKGROUND

2013: The applicant started the project on 2013, on that time the property was splited into two portion by a 20' Metro Vancouver abandoned utility property. Developing on 2 parcel of land seperately under Rental 100 program was not supported by planning department. Planner suggested the lots to be consolidated.

2014: After a great effect the developer has made an agreement with Metro Vancouver to purchase the 20' Metro Vancouver property and Metro vancouver has agreed. The developer could make application for development permit and rezoning. Then the applicant prepared revised drawings based on consolidate properties (the 20' Metro Vancouver property already has been purchased by the developr). 2017: Finally at June 28, 2017 an open house was held by owner to hear public feedback on the priliminary proposal on the development. The nieghbour at 3309 Price St. wasn't happy from the development, and other neighbours asked for less density and height, in other side there were some comments that neighbours supported a new development on the empty land lying there for years After open house upon an agreement the developer purchased the property at 3309 Price street. and City asked for more setbacks to accomodate neighbours request for less density and height.

Feb 20, 2018: Now 4 piece of land has been consolidated to serve the new development. The new proposal includes: 30 family oriented units, 8 stacked townhouses, 4 artist studio (loft), and 498 m2 commercial area.

8.5X11 Public VanMap





MATTHEW CHENG ARCHITECT INC.

Unit 202 - 670 EVANS AVENUE VANCOUVER, BC V6A 2K9 Tel: (604) 731-3021 / Cel: (604) 649-0669 Email: matthew@mcai.ca

THIS DRAWING MUST NOT BE SCALED. THE GENERAL CONTRACTOR SHALL VERIFY ALL DIMENSIONS AND LEVELS PRIOR TO COMMENCEMENT TO WORK. ALL ERRORS AND OMISSIONS SHALL BE REPORTED IMMEDIATELY TO THE ARCHITECT. COPYRIGHT RESERVED. THIS PLAN AND DESIGN ARE AND AT ALL TIMES REMAIN THE EXCLUSIVE PROPERTY OF MATTHEW CHENG ARCHITECT INC. AND MAY NOT BE USED OR REPRODUCED WITHOUT PRIOR WRITTEN CONSENT.

Revision

Context Plan

SECONDARY SCHOOL BUS STATION PRESCHOOL SITE 50/18 ELEMENTRY SCHOOL RUPERT ST Google Earth Google Earth

Proi

4506 Rupert St. Vancouver BC

Rezoning
Rationale&
Context Plan

Drawn: HR

Checked:MC


Scale: 1" = 20'-0"

Project Number:

evision Date: Dwg.

Print Date: A102

Design Rationale

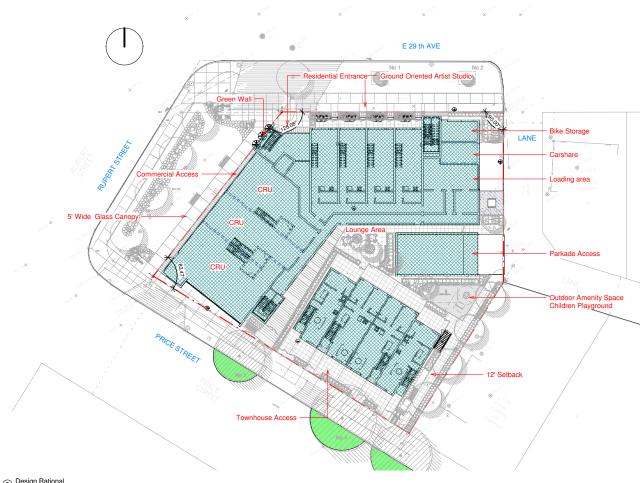


3 Design Rational 1" = 20'-0"

Key Design Strategies

- Orient the main side towards the south +_30* East or west, and use large south facing windows as much as possible
- Minimize unwanted shade to allow passive solar energy use
 Use landscaping consistent with required amounts of shading at different time of the yeardeciduous trees will offer shade in summer but access solar heat in winter
- Use a compact building form to limit heat loss
- Provide operable window on all building elevations
- Row and multi-story building designs to maximize efficiencies

Use and Density

An Interior amenity area of 909.44 sf and a 1398.29 sf open space are situated in the project's centre and side yard. A portion of the outdoor area will be devoted to children's play. Sir Wilfred Elementry School immediately adjacent and the open space around the school has an extensive playground area.

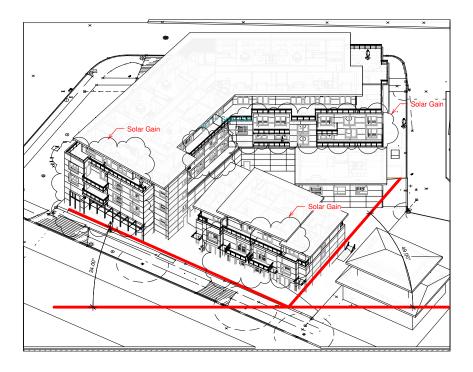



MATTHEW CHENG ARCHITECT INC.

Unit 202 - 670 EVANS AVENUE VANCOUVER, BC V6A 2K9 Tel: (604) 731-3021 / Cel: (604) 649-0669 Email: matthew@mcai.ca

THIS DRAWING MUST NOT BE SCALED. THE GENERAL CONTRACTOR SHALL VERIFY ALL DIMENSIONS AND LEVELS PRIOR TO COMMENCEMENT TO WORK. ALL ERRORS AND OMISSIONS SHALL BE REPORTED IMMEDIATELY TO THE ARCHITECT. COPYRIGHT RESERVED. THIS PLAN AND DESIGN ARE AND AT ALL TIMES REMAIN THE EXCLUSIVE PROPERTY OF MATTHEW CHEGO ARCHITECT INC. AND MAY NOT BE USED OR REPRODUCED WITHOUT PRIOR WRITTEN CONSENT.

Average Rental rate

UNITS											
1BED	AREA	2BED	AREA	3BED	AREA						
SF	SF	SF	SF	SF	SF						
Loft1	480.00	TH4	659.44	201	858.82						
Loft2	476.98	TH5	653.48	301	854.50						
Loft3	476.98	202	606.65								
Loft4	476.30	203	765.84	TH1	883.82						
ГН2	519.56	204	665.69	TH3	971.31						
TH7	528.23	207	634.07	TH6	961.26						
205	468.56	302	608.96	TH8	899.89						
206	506.23	303	767.81								
208	483.17	304	665.69								
209	527.82	307	633.04								
210	527.38	401	592.22								
211	466.24	406	657.11								
305	468.22										
306	506.40										
808	487.56										
309	529.80										
310	549.71						Avera	ge rental r	ate by Rental Incer	ntive Guide	lines
11	493.14					STUDIO			EAST AREA RENT		\$
402	546.08					450.00	SQ FT	\$	1360.00		3.02
403	660.57										
404	487.07					1BEDROOI	M				
405	490.89					600.00	SQ FT	\$	1747.00		2.91
407	451.03										
408	509.16					2BEDROO!	M				
						830.00	SQ FT	\$	2308.00		2.78
						3BEDROOI					
						1044.00	SQ FT	\$	3030.00		2.90
							RENTAL PR	OPOSAL			
	TOTAL 1B		TOTAL 2B		TOTAL 3B	STUDIO				1100.00	
	12117.08		7910.00		5429.60	1BEDROO	M		\$	1380.00	
					Average						
	Average 1B		Average 2B		3B	2BEDROO!	VI			1880.00	
	526.83		659.17		904.93	3BEDROO!	M		\$	2300.00	

4506 Rupert St. Vancouver BC

Sheet Title
Design Rationale

Drawn: Author Checker Checker

Scale: 1" = 20'-0"

Revision Date:

A103 Print Date: 02262018

Design Rationale



MATTHEW CHENG

ARCHITECT INC.
Unit 202 - 670 EVANS AVENUE
VANCOUVER, BC V6A 2K9
Tel: (604) 731-3021 / Cel: (604) 649-0669
Email: matthew@mcai.ca

THIS DRAWING MUST NOT BE SCALED. THE GENERAL CONTRACTOR SHALL VERIFY ALL DIMENSIONS AND LEVELS PRIOR TO COMMENCEMENT TO WORK. ALL ERRORS AND OMISSIONS SHALL BE REPORTED IMMEDIATELY TO THE ARCHITECT. COPYREIF RESERVED. THIS PLAN AND DESIGN ARE AND AT ALL TIMES REMAIN THE EXCLUSIVE PROPERTY OF MATTHEW CHENG ARCHITECT INC. AND MAY NOT BE USE OR REPRODUCED WITHOUT PRIOR WRITTEN CONSENT.

4506 Rupert St. Vancouver BC

Design Rationale

Drawn: HR Checked:MC

Revision Date:

Print Date: 02262018 A104



4 Rupert St, and E29th Ave.





1) Rupert St, and Price St.


5 Lane


Street Scape




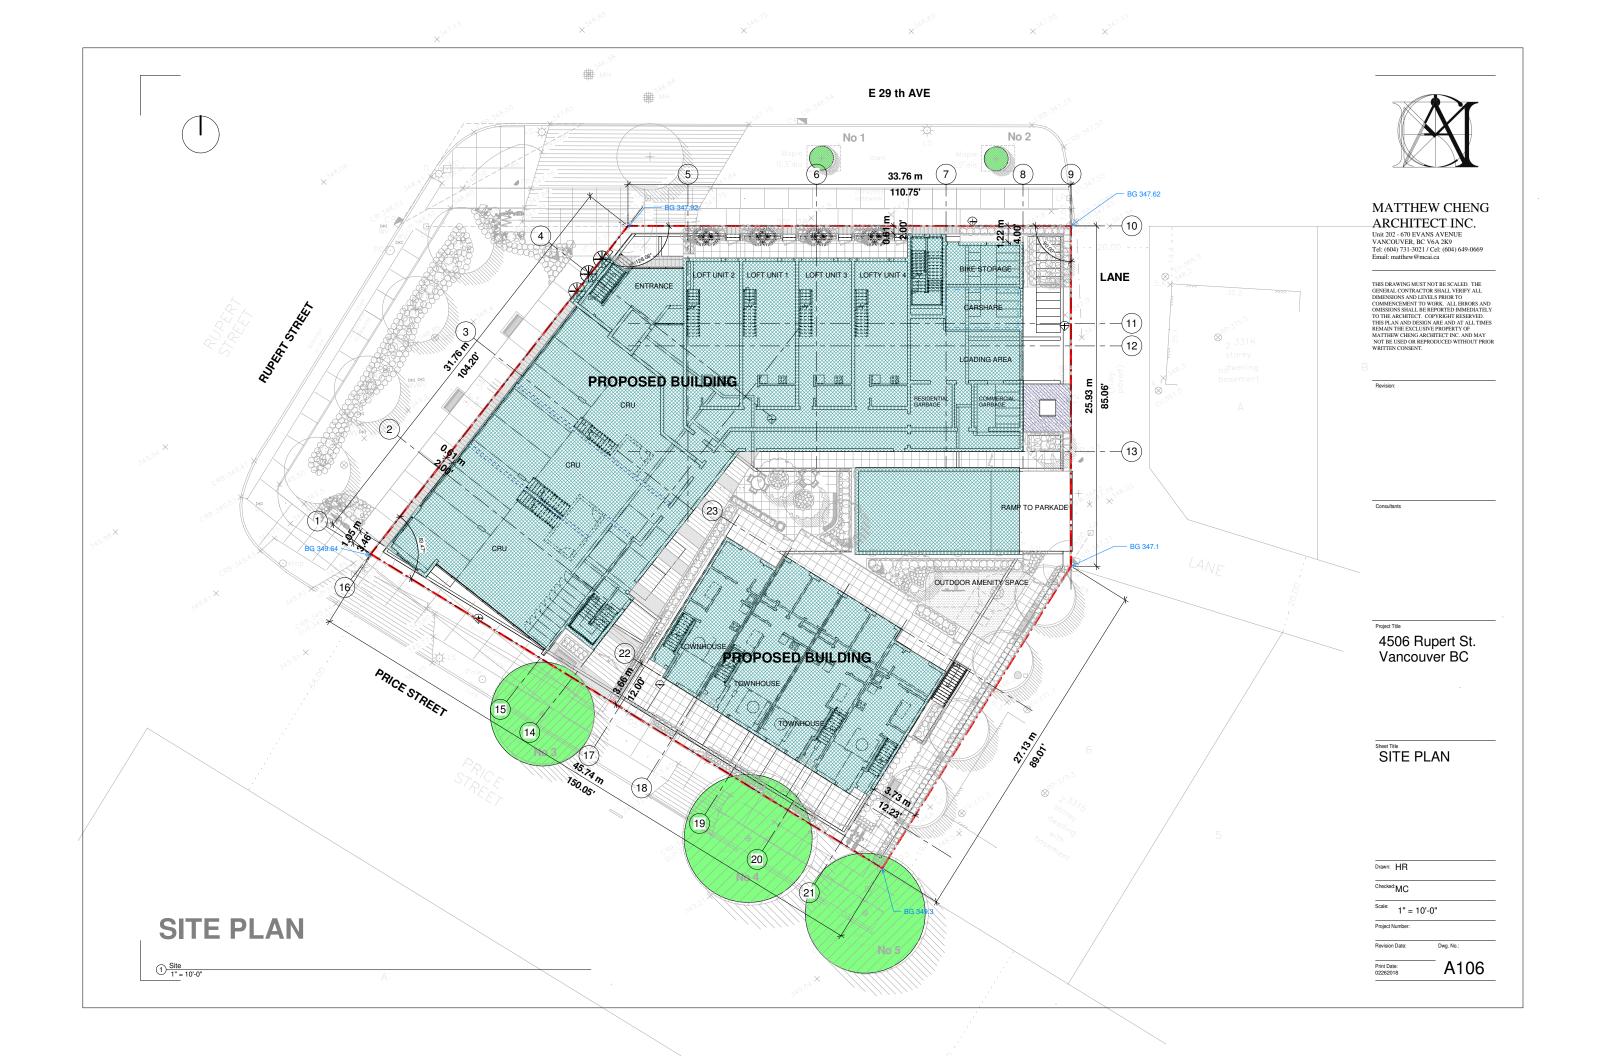


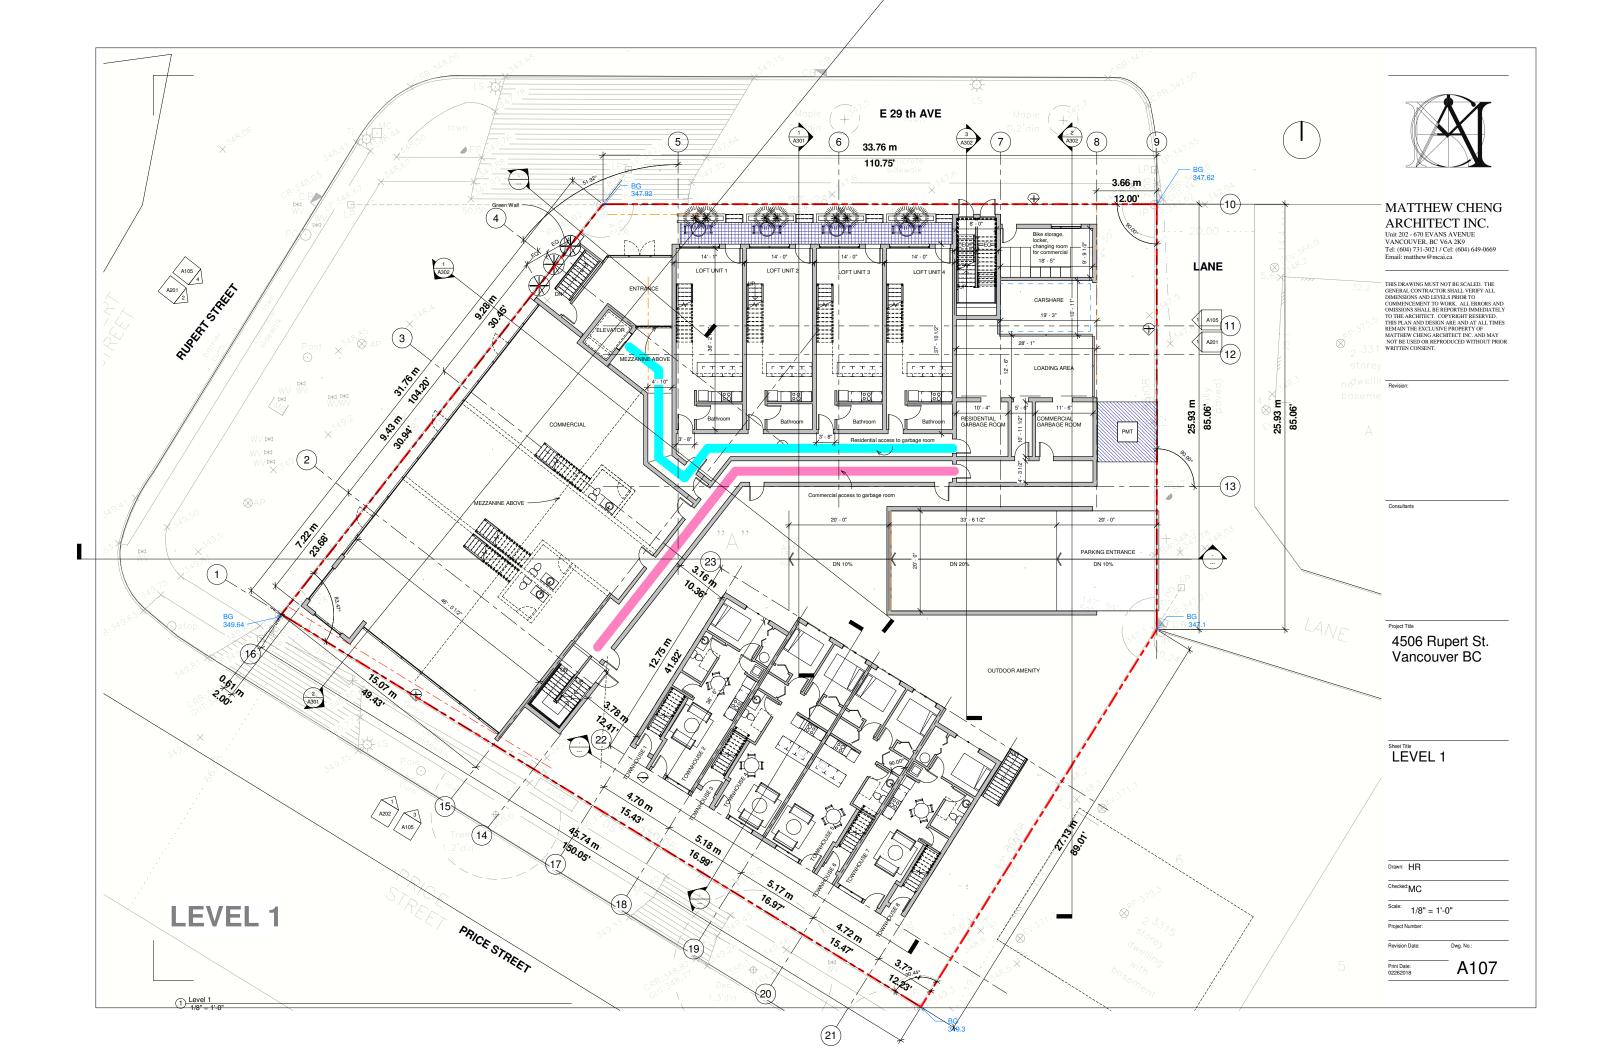


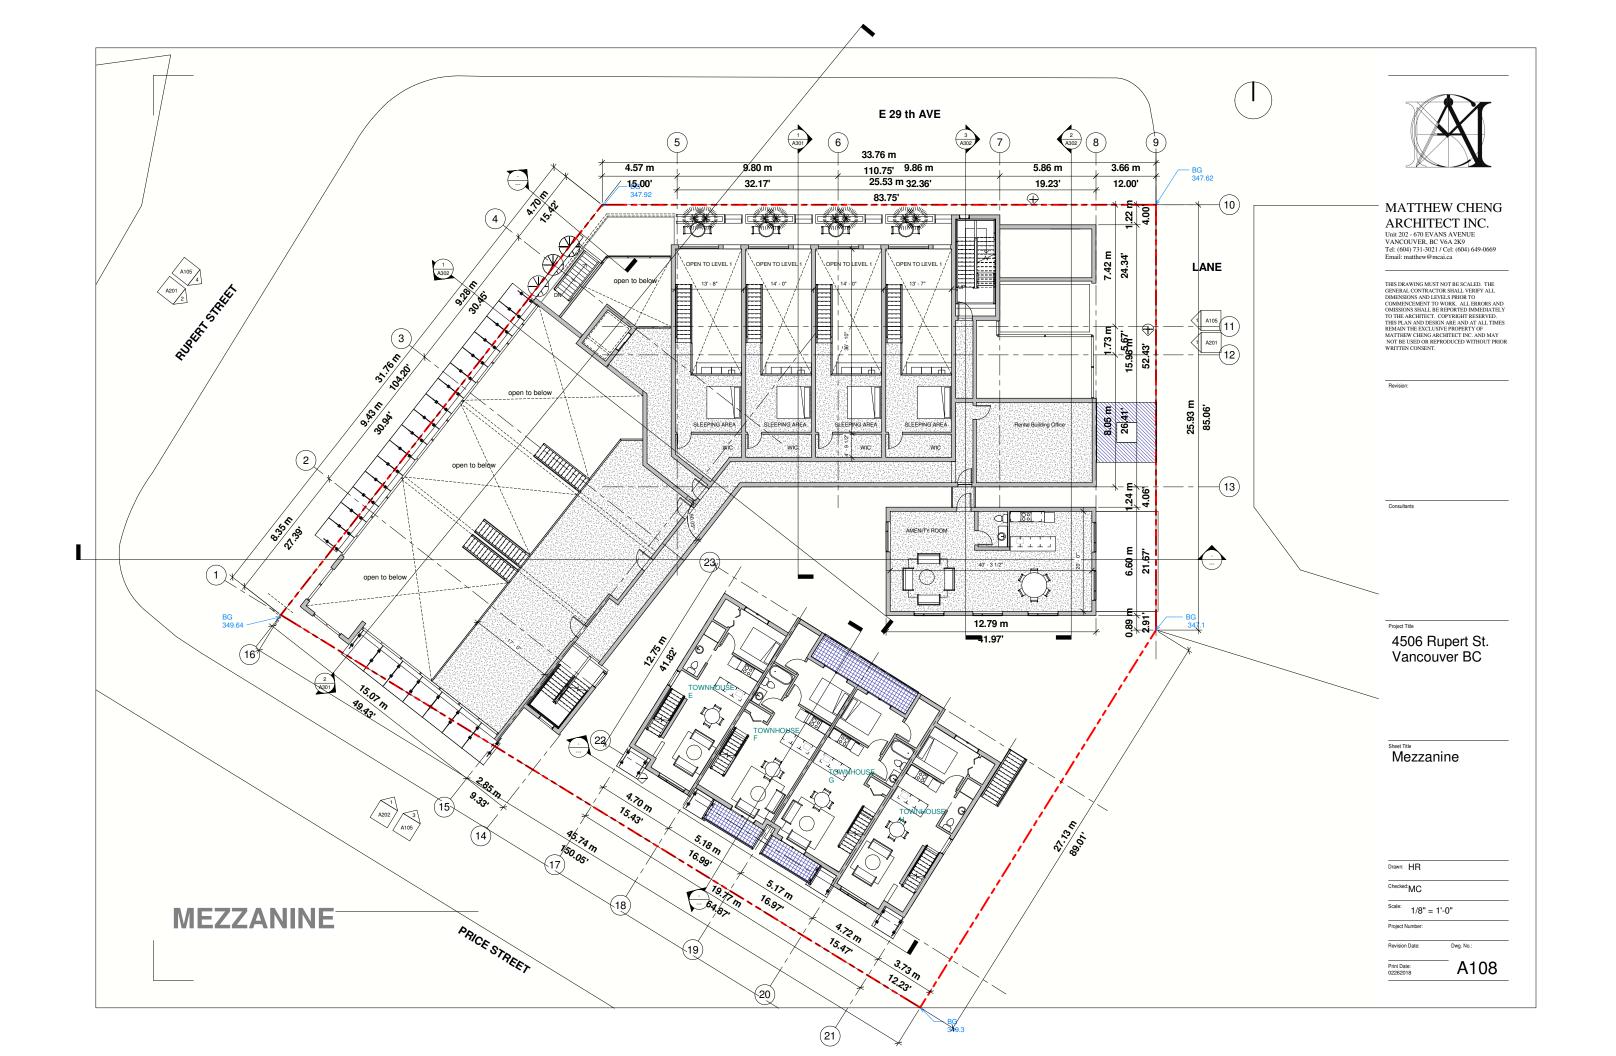


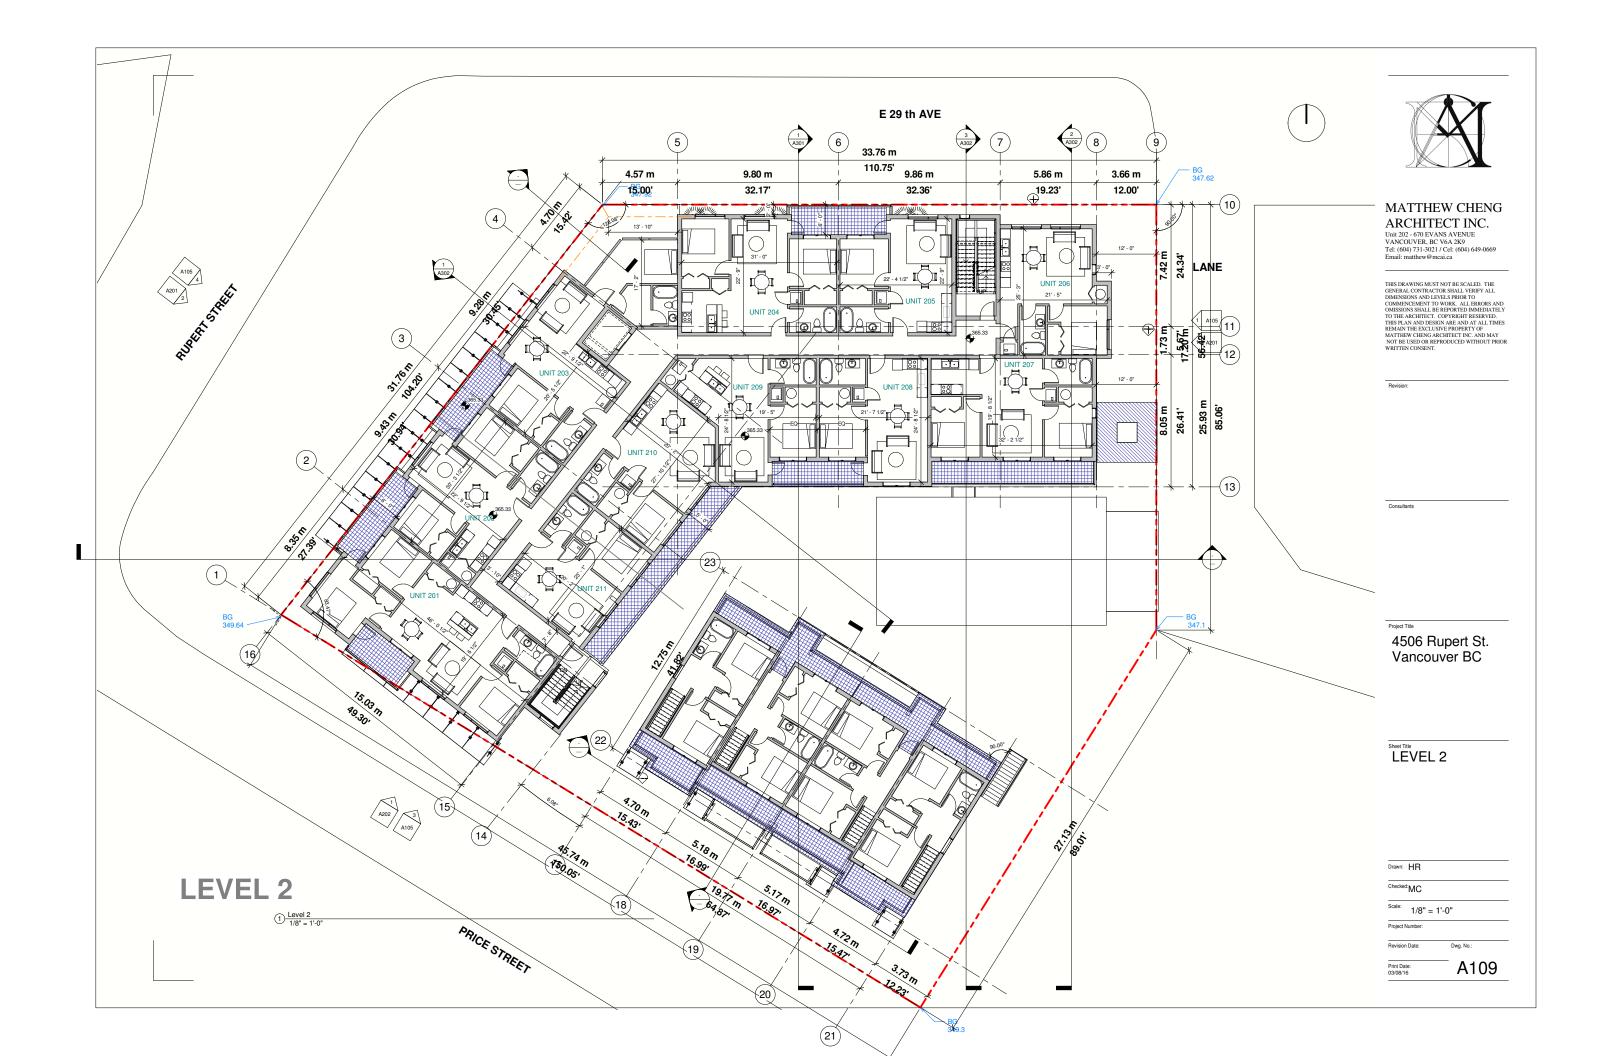

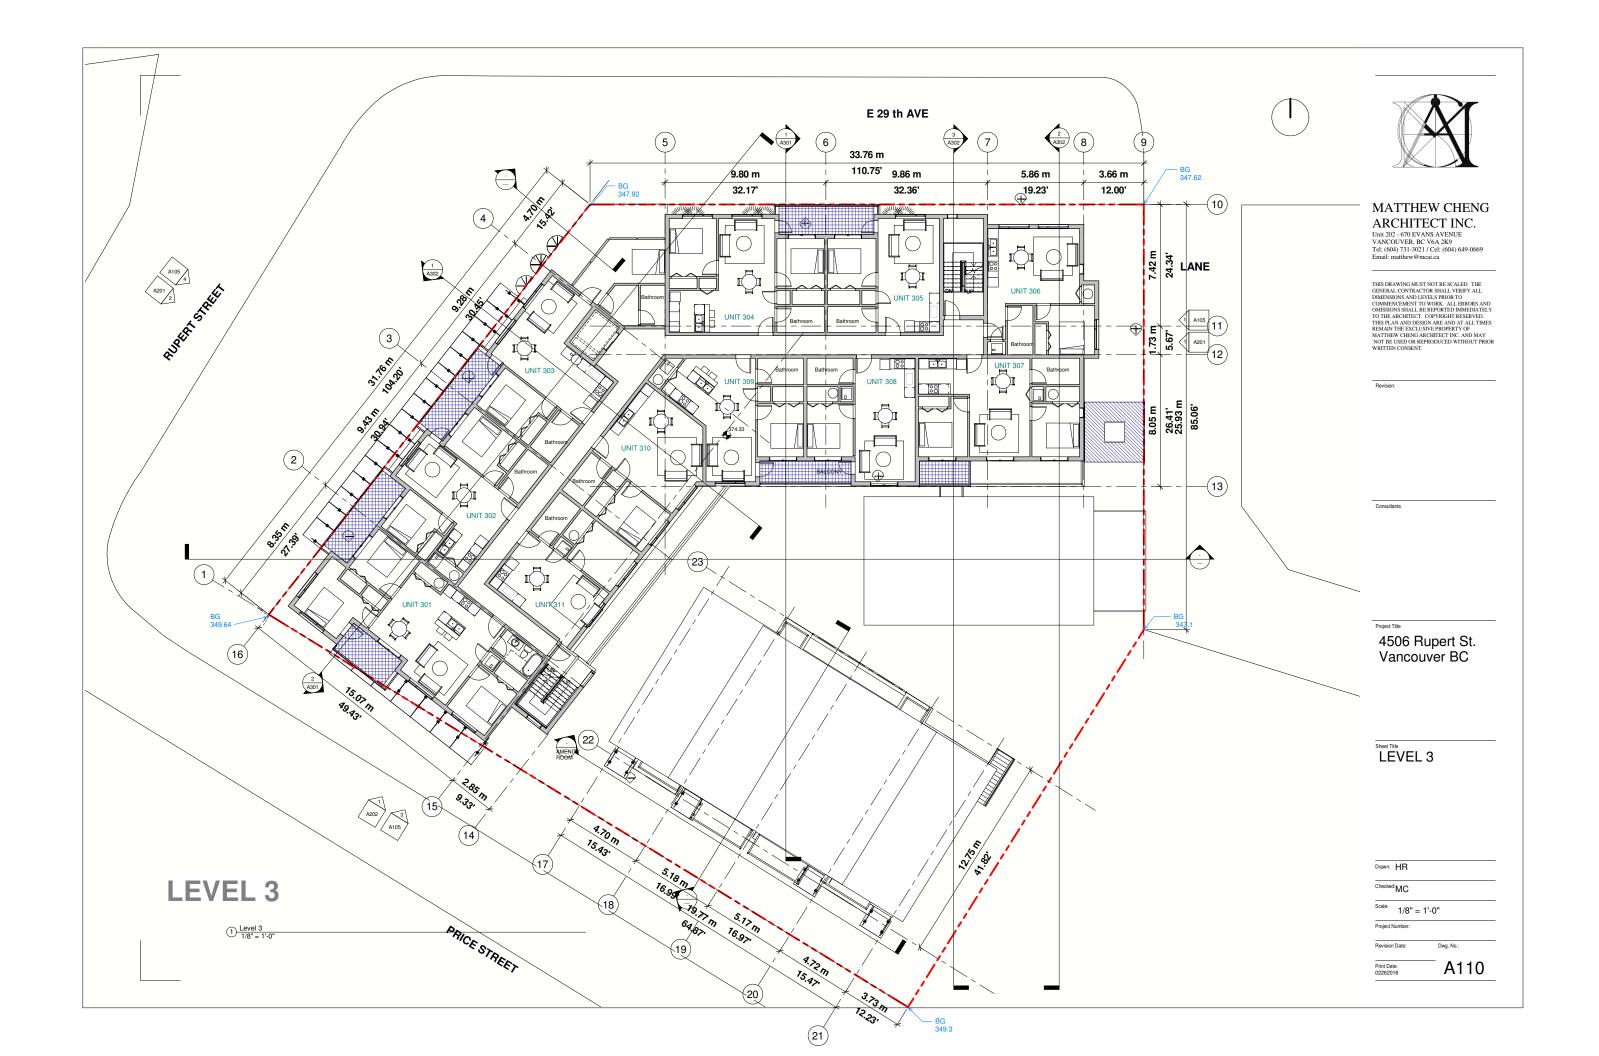

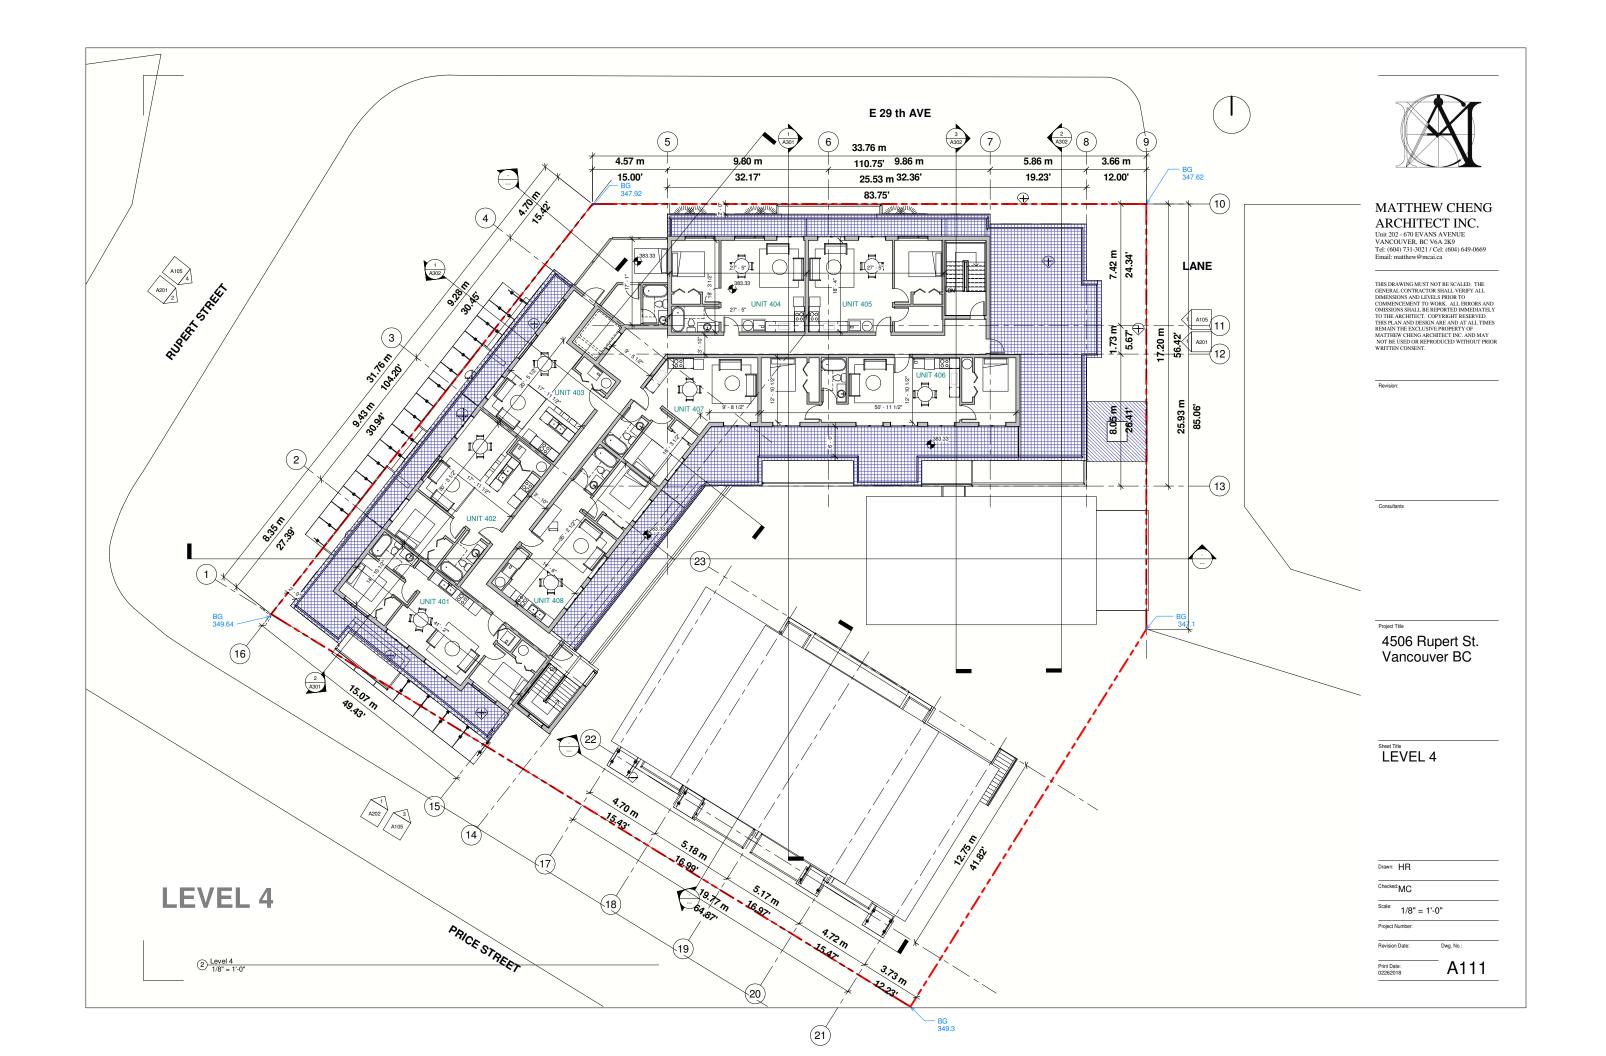

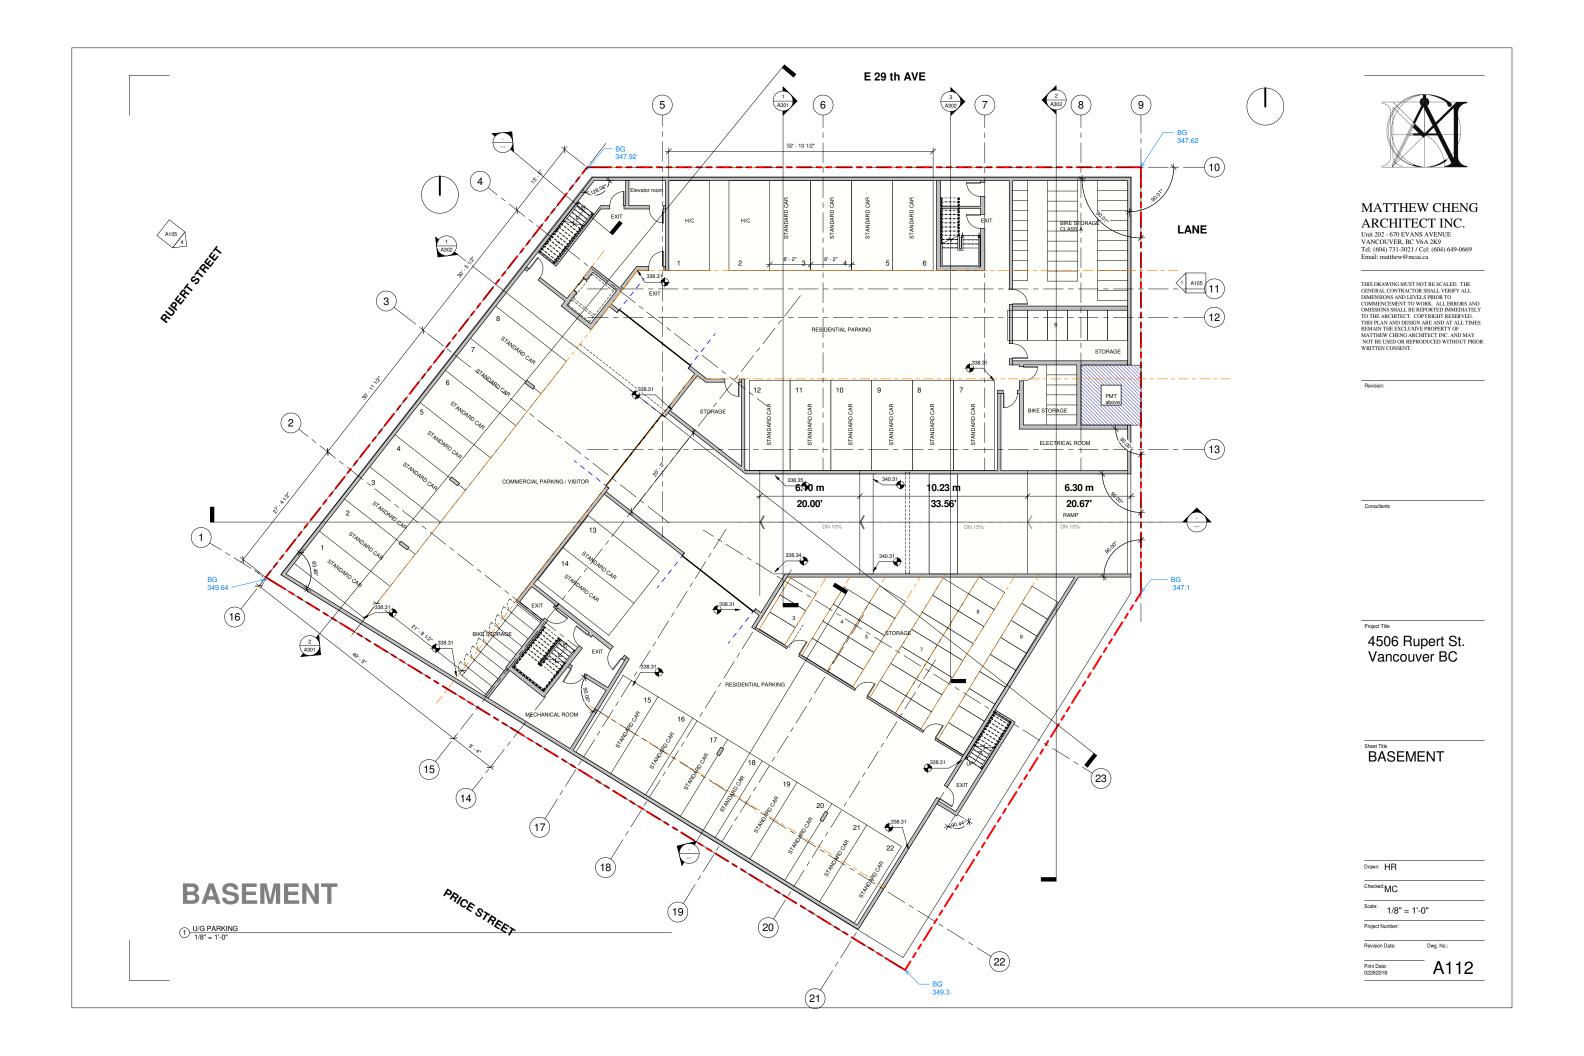

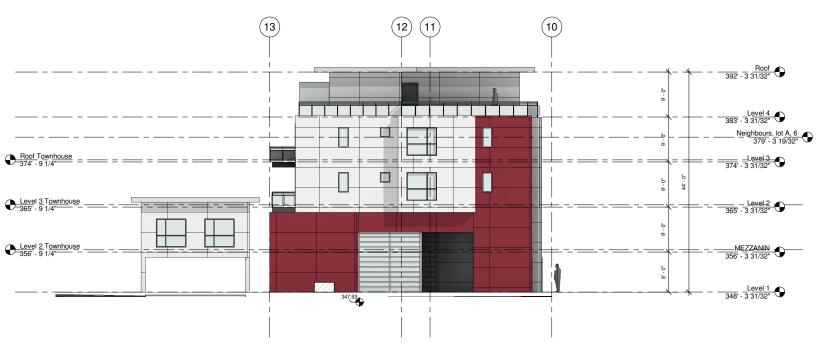




MATTHEW CHENG ARCHITECT INC.

Unit 202 - 670 EVANS AVENUE VANCOUVER, BC V6A 2K9 Tel: (604) 731-3021 / Cel: (604) 649-0669 Email: matthew@mcai.ca

THIS DRAWING MUST NOT BE SCALED. THE GENERAL CONTRACTOR SHALL VERIFY ALL DIMENSIONS AND LEVELS PRIOR TO COMMENCEMENT TO WORK. ALL ERRORS AND OMISSIONS SHALL BE REPORTED IMMEDIATELY TO THE ARCHITECT. COPYREIF RESERVED. THIS PLAN AND DESIGN ARE AND AT ALL TIMES REMAIN THE EXCLUSIVE PROPERTY OF MATTHEW CHENG ARCHITECT INC. AND MAY NOT BE USE OR REPRODUCED WITHOUT PRIOR WRITTEN CONSENT.

Revisio

EAST ELEVATION

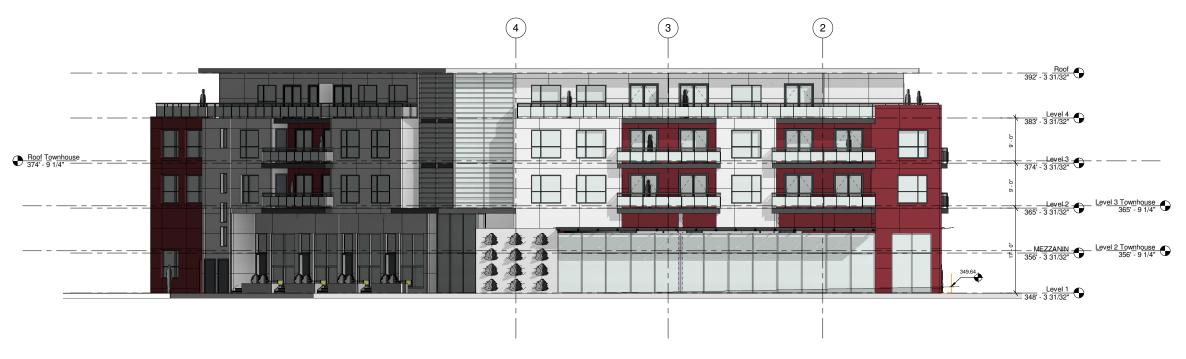

Consultants

Project 1

4506 Rupert St. Vancouver BC

EAST, WEST

Drawn: HR

Checked: MC

Scale: 1/8" = 1'-0"

Project Number:

Revision Date: Dwg. N

Print Date: A201

WEST ELEVATION

2 West 1/8" = 1'-0"

1 East 1/8" = 1'-0"



MATTHEW CHENG ARCHITECT INC.

Unit 202 - 670 EVANS AVENUE VANCOUVER, BC V6A 2K9 Tel: (604) 731-3021 / Cel: (604) 649-0669 Email: matthew@mcai.ca

THIS DRAWING MUST NOT BE SCALED. THE GENERAL CONTRACTOR SHALL VERIFY ALL DIMENSIONS AND LEVELS PRIOR TO COMMENCEMENT TO WORK. ALL ERRORS AND OMISSIONS SHALL BE REPORTED IMMEDIATELY TO THE ARCHITECT. COPYRIGHT RESERVED. THIS PLAN AND DESIGN ARE AND AT ALL TIMES REMAIN THE EXCLUSIVE PROPERTY OF MATTHEW CHEGO ARCHITECT INC. AND MAY NOT BE USED OR REPRODUCED WITHOUT PRIOR WRITTEN CONSENT.

4506 Rupert St. Vancouver BC

NORTH, SOUTH **ELEVATION**

Drawn: HR


Checked: MC

Scale: 1/8" = 1'-0"

Print Date: 02262018

Revision Date:

A202

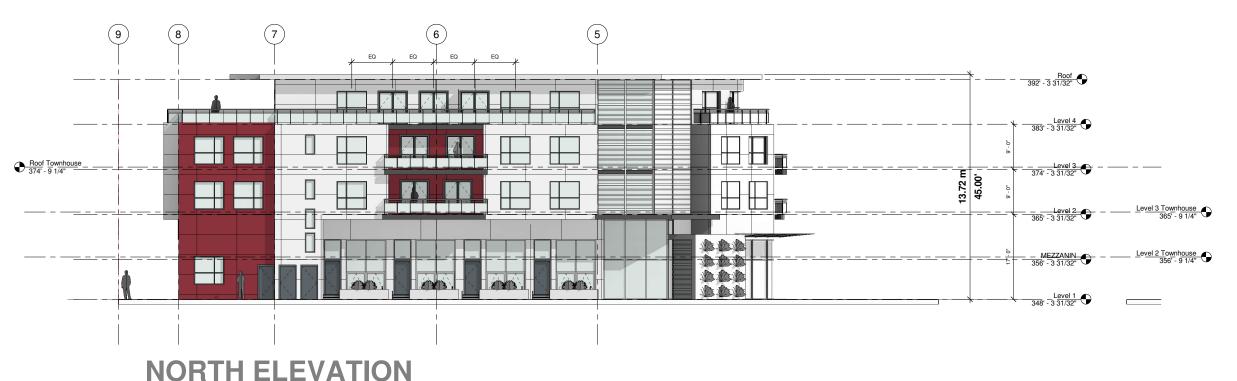


North
1/8" = 1'-0"




SOUTH ELEVATION

1) South 1/8" = 1'-0"

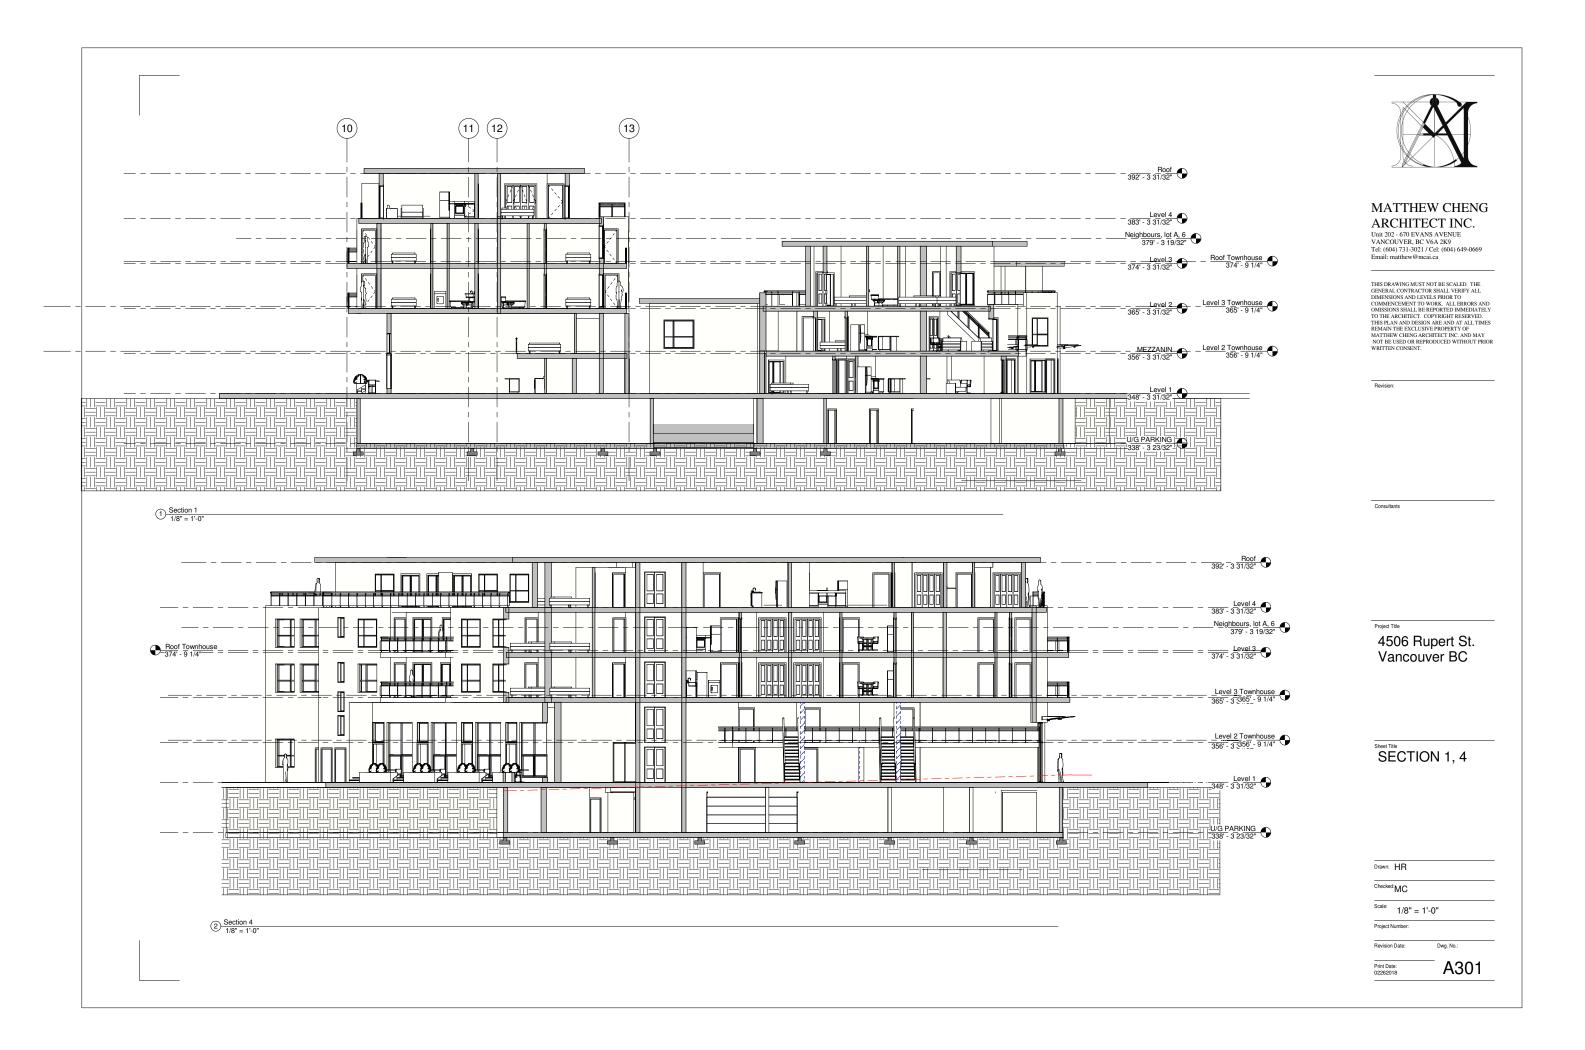



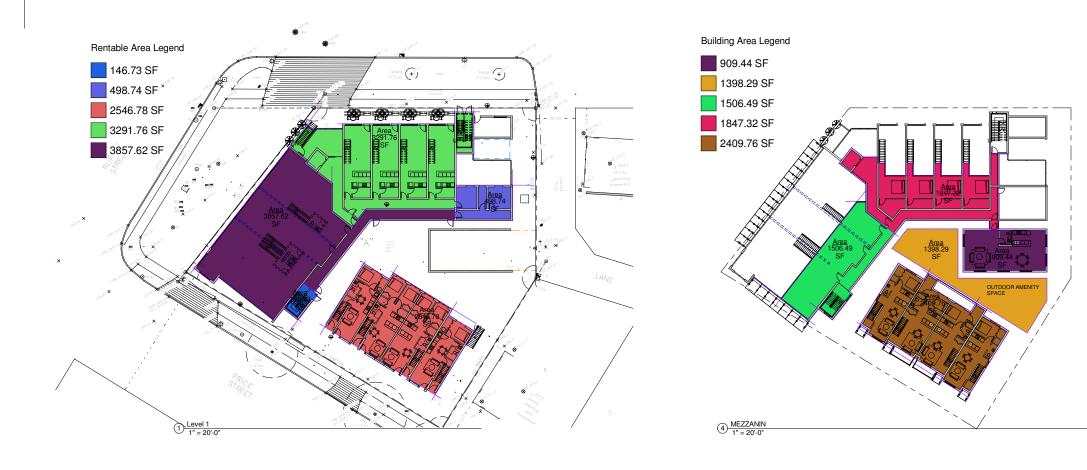



MATTHEW CHENG

ARCHITECT INC.
Unit 202 - 670 EVANS AVENUE
VANCOUVER, BC V6A 2K9
Tel: (604) 731-3021 / Cel: (604) 649-0669
Email: matthew@mcai.ca

THIS DRAWING MUST NOT BE SCALED. THE GENERAL CONTRACTOR SHALL VERIFY ALL DIMENSIONS AND LEVELS PRIOR TO COMMENCEMENT TO WORK. ALL ERRORS AND OMISSIONS SHALL BE REPORTED IMMEDIATELY TO THE ARCHITECT. COPYREDIFF RESERVED. THIS PLAN AND DESIGN ARE AND AT ALL TIMES REMAIN THE EXCLUSIVE PROPERTY OF MATTHEW CHENG ARCHITECT INC. AND MAY NOT BE USED OR REPRODUCED WITHOUT PRIOR WRITTEN CONSENT.



4506 Rupert St. Vancouver BC

FLOOR AREA


Drawn: HR

Checked: MC

Scale: 1" = 20'-0"

Revision Date:

A401 Print Date: 02262018

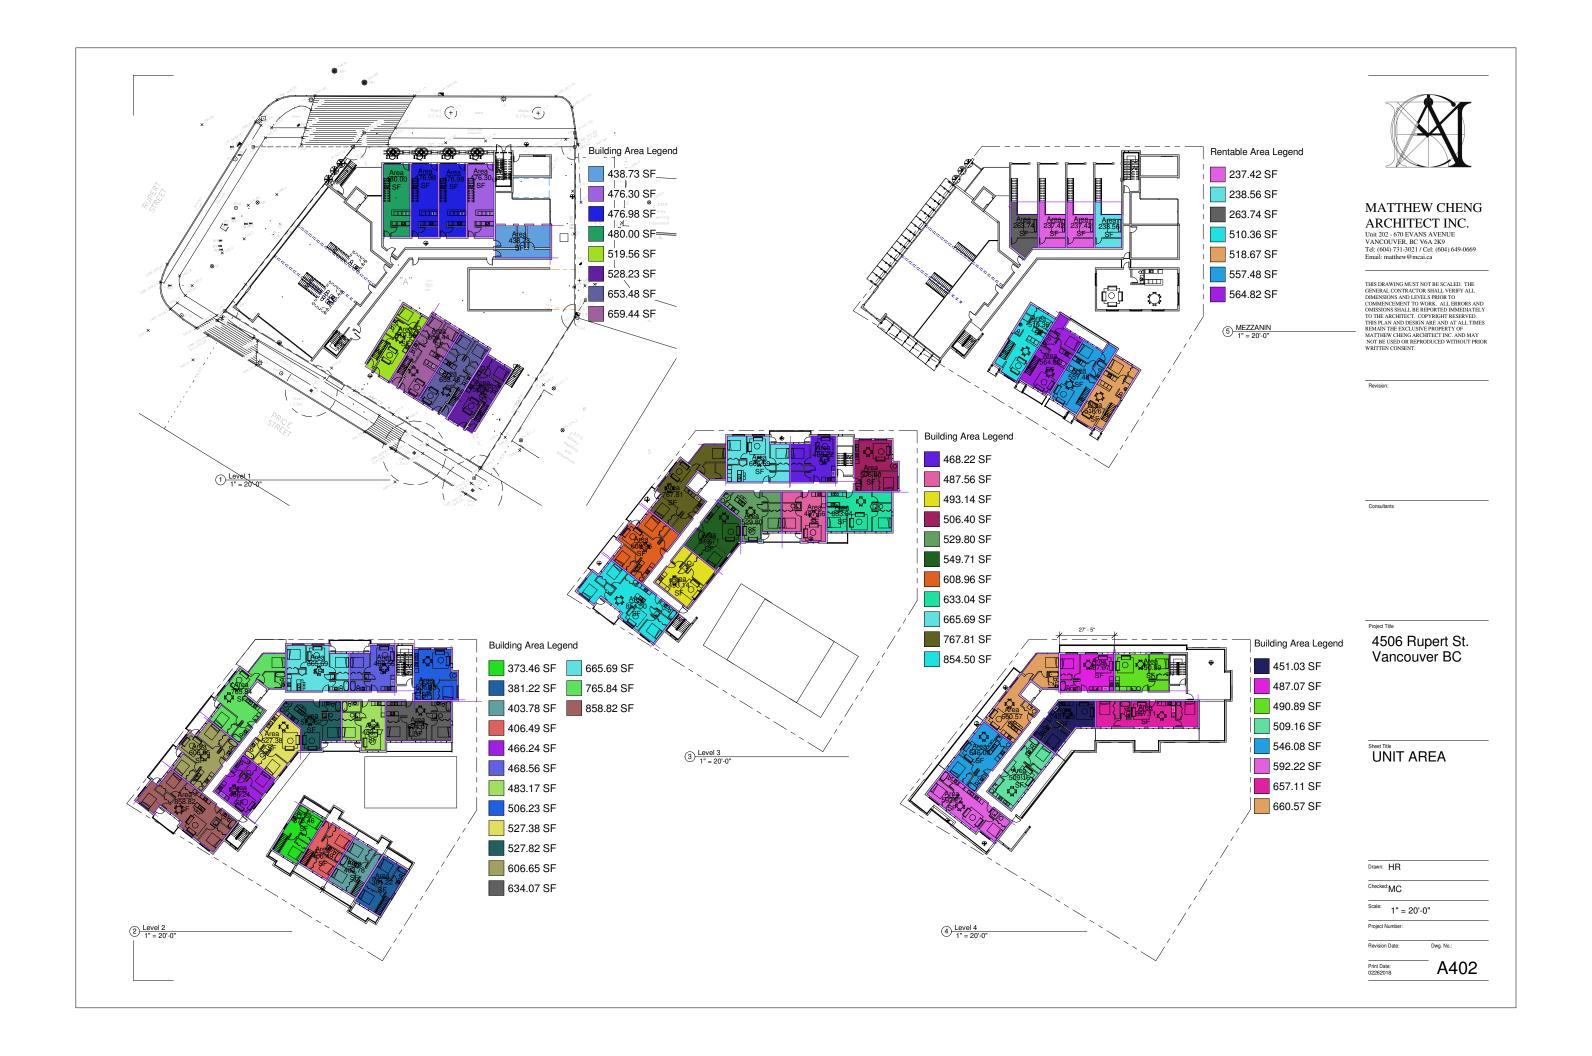














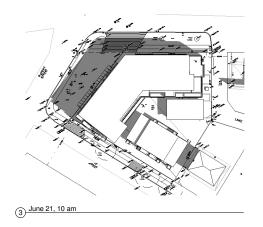


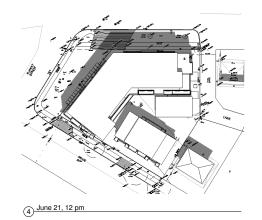


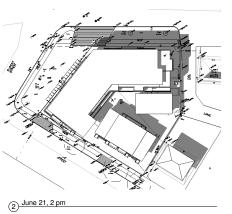

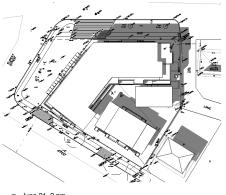


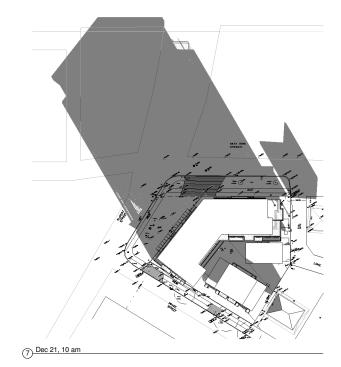


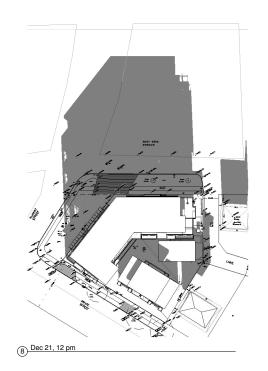

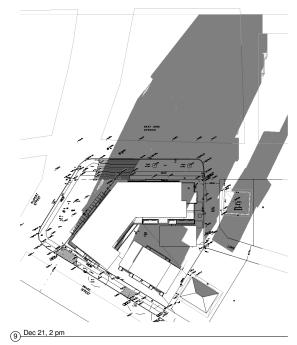

6 March 21, 2 pm

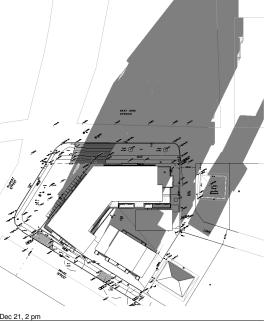

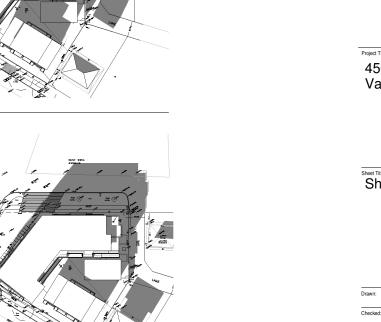



MATTHEW CHENG

ARCHITECT INC.
Unit 202 - 670 EVANS AVENUE
VANCOUVER, BC V6A 2K9
Tel: (604) 731-3021 / Cel: (604) 649-0669
Email: matthew@mcai.ca


THIS DRAWING MUST NOT BE SCALED. THE GENERAL CONTRACTOR SHALL VERIFY ALL DIMENSIONS AND LEVELS PRIOR TO COMMENCEMENT TO WORK. ALL ERRORS AND OMISSIONS SHALL BE REPORTED IMMEDIATELY TO THE ARCHITECT. COPYRIGHT RESERVED. THIS PLAN AND DESIGN ARE AND AT ALL TIMES REMAIN THE EXCLUSIVE PROPERTY OF MATTHEW CHENG ARCHITECT INC. AND MAY NOT BE USED OR REPRODUCED WITHOUT PRIOR WRITTEN CONSENT.


Revision:			

Project Title
4506 Rupert St.
Vancouver BC

Sheet Title	
Shadow	Study

Drawn: HR	
Checked: MC	
Scale:	
Project Number:	
Revision Date:	Dwg. No.:
Print Date: 02262018	_ A601

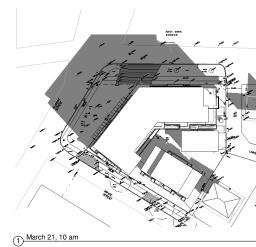

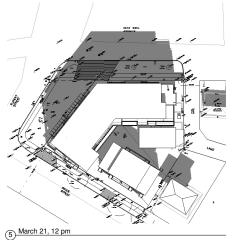



© Copyright reserved. This drawing and design is the property of PMG Landscape Architects and may not be reproduced or used for other projects without their

Suite C100 - 4185 Still Creek Drive Burnaby, British Columbia, V5C 6G9 p: 604 294-0011; f: 604 294-0022

WITH: MATTHEW CHENG ARCHITECT INC.

NO. DATE REVISION DESCRIPTION DR. CLIENT: 1083195 B.C. LTD. c/o RBC HOLDINGS LTD.

RESIDENTIAL / **COMMERCIAL BUILDING**

4506 RUPERT STREET VANCOUVER

LANDSCAPE PLAN


DATE: January 18, 2018

SCALE: 3/32"=1'-0" DRAWN: DD

DRAWING NUMBER:

17-269

DESIGN: DD CHK'D. PCM

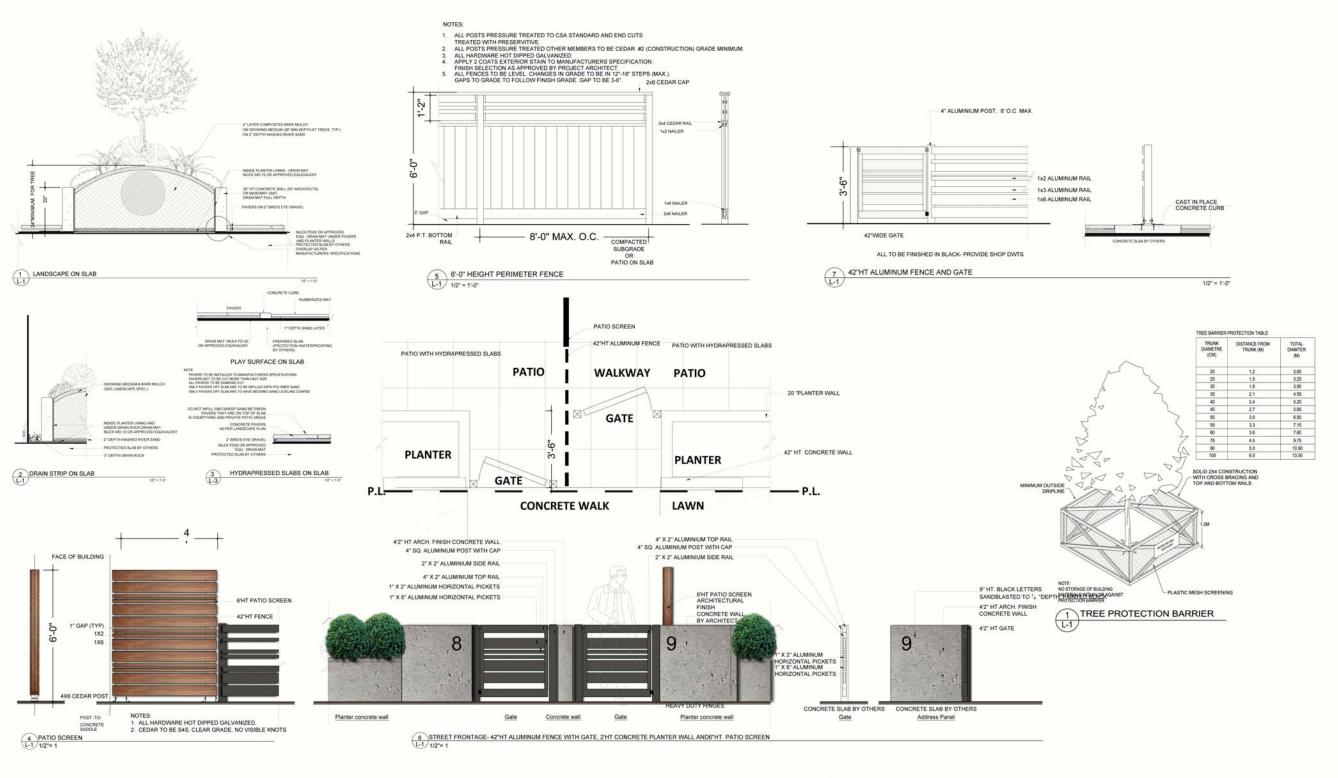

3.2 All landscaping and treatment of open portions of the site shall be completed in accordance with the approved drawing prior to the issuance of any required occupancy permit, or any use or occupancy of the proposed development not requireing an occupancy permit, and thereafter permanency maintained in good condition.

(Note to applicant: In cases where it is not practical, due to adverse weather conditions or other mitigating factors, to complete the landscaping prior to occupancy of building, the City will accept an Irrevocable Letter of Credit (amount to be determined by the City) as guarantee for completion of the work by an agreed upon date.)

3.3 In accordance with Protection of Trees By-Low number 9958, the removal and replacement of trees is permited only as indicated on the approved Development Permit drawings.

NOTE:

PROVISION OF NEW TREES ADJACENT TO THE DEVELOPMENT SITE, TO BE CONFIRMED PRIOR TO THE ISSUANCE OF THE BUILDING PERMIT;

NOTE TO APPLICATION:

CONTACT EILEEN CURRAN, STREETS ENGINEERING AT 604-871-6131

TO CONFIRM TREE PLANTING LOCATIONS AND PARK BOARD AT 604-257-8587 FOR TREE SPECIES SELECTION AND

FINAL SPACING, QUANTITY AND TREE SPECIES TO THE SATISFACTION OF THE GENERAL MANAGER OF ENGINEERING SERVICES.

NEW TREES MUST BE OF GOOD STANDARD, MINIMUM 6cm CALIPER, AND INSTALLED WITH APPROVED ROOT BARRIERS, TREE GUARDS AND APPROPRIATE SOIL/STRUCTURAL SOIL. ROOT BARRIERS SHALL BE 8' LONG AND 18" DEEP. PLANTING DEPTH OF ROOT BALL MUST BE BELOW SIDEWALK GRADE. CALL PARK BOARD FOR INSPECTION AFTER TREE PLANTING

- A LANDSCAPE PLAN IS TO BE SUBMITTED FOR REVIEW TO ENGINEERING SERVICES A MINIMUM OF 8 WEEKS PRIOR TO START OF ANY CONSTRUCTION PROPOSED FOR PUBLIC PROPERTY. NO WORK ON PUBLIC PROPERTY MAY BEGIN UNTIL SUCH PLANS RECEIVE "FOR CONSTRUCTION" APPROVAL AND RELATED PERMIS ARE ISSUED. PLEASE CONTACT KEVIN CAVELL AT 604-873-7773 FOR DETAILS.

Copyright reserved. This drawing and design is the property of PMG Landscape Architects and may not be roduced or used for other projects without their

Suite C100 - 4185 Still Creek Dr Burnaby, British Columbia, V5C 6G9 p: 604 294-0011; f: 604 294-0022

NO. DATE REVISION DESCRIPTION

CLIENT: 1083195 B.C. LTD. c/o RBC HOLDINGS LTD.

WITH: MATTHEW CHENG ARCHITECT INC.

RESIDENTIAL / **COMMERCIAL BUILDING**

4506 RUPERT STREET VANCOUVER

LANDSCAPE DETAILS

DATE: January 18, 2018

17-269

DESIGN: DD CHK'D: PCM